

OWNER RALEIGH, NC 27601 (919) 996-4781 RALEIGH, NC 27601 (919) 838-9337 RALEIGH, NC 27609 (919) 840-9300 ELTON SMITH: esmith@sigmaes.com

DRAWING INDEX GENERAL CITY OF RALEIGH PARKS, RECREATION, AND CULTURAL RESOURCES G000 COVER 222 W HARGETT STREET STE. 601 G001 **CODE SUMMARY** INTERIORS FLOOR PLANS CARLOS REYES: carlos.reyesmerced@raleighnc.gov ARCHITECT INTERIOR ELEVATIONS- MEN'S LOCKER ROOM INTERIOR ELEVATIONS- MEN'S LOCKER ROOM OSTERLUND ARCHITECTS, PLLC ENLARGED WOMEN'S LOCKER ROOM PLAN 5 W HARGETT STREET 310 ENLARGED MEN'S LOCKER ROOM PLAN INTERIOR DETAILS 1601 INTERIOR SCHEDULES KRISTEN OSTERLUND: kristen@osterlundarchitects.com PLUMBING

INTERIOR DESIGNER OSTERLUND ARCHITECTS, PLLC 5 W HARGETT STREET 310 RALEIGH, NC 27601 (919) 838-9337 ASHLEY SESSOMS: ashley@osterlundarchitects.com

PME ENGINEER SIGMA ENGINEERING SOLUTIONS, P.C. 5909 FALLS OF NEUSE ROAD-SUITE 101

INTERIOR ELEVATIONS- WOMEN'S LOCKER ROOM INTERIOR ELEVATIONS- WOMEN'S LOCKER ROOM PLUMBING COVER SHEET PLUMBING FLOOR PLAN- DEMOLITION P200 PLUMBING FLOOR PLAN- NEW WORK ELECTRICAL ELECTRICAL LEGENDS, SYMBOLS, NOTES ELECTRICAL DEMOLITION FLOOR PLAN ELECTRICAL NEW WORK FLOOR PLAN **ELECTRICAL DETAILS**

POWER RISER AND SCHEDULES

PROJECT LOCATION





LOCATION MAP

10

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CONSULTANTS:

PROJECT No.:

2325

THHOUS

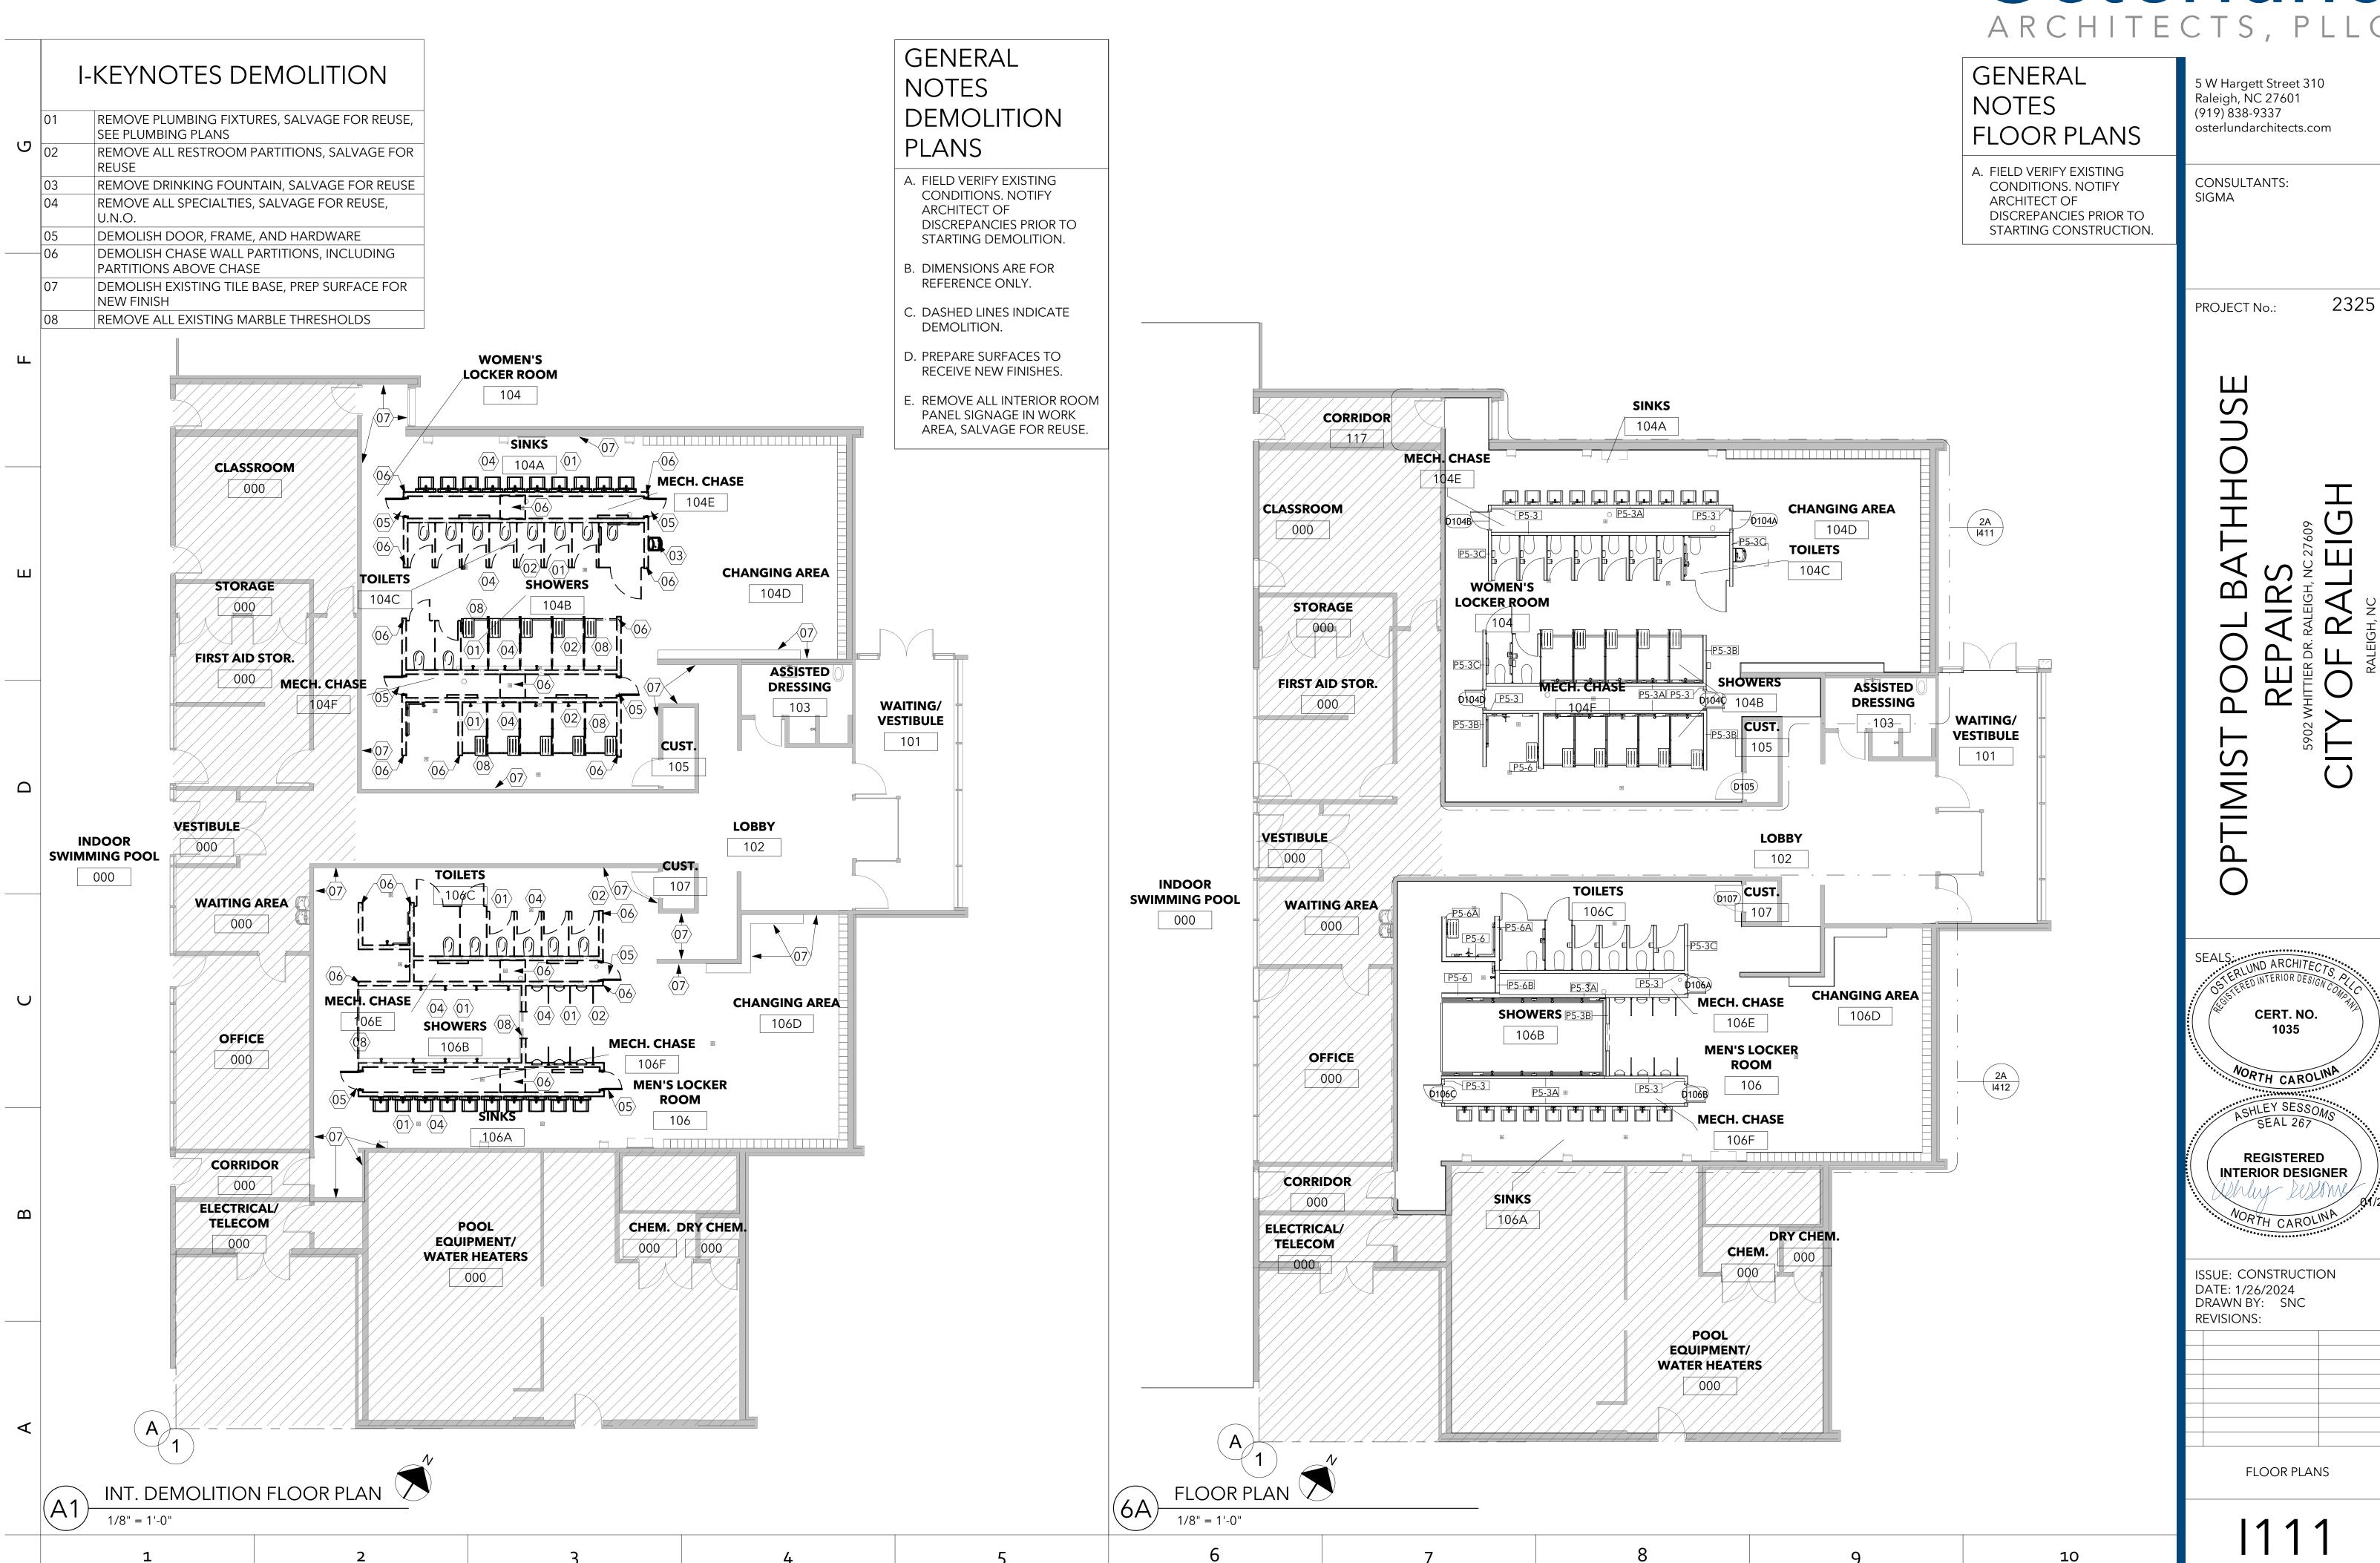


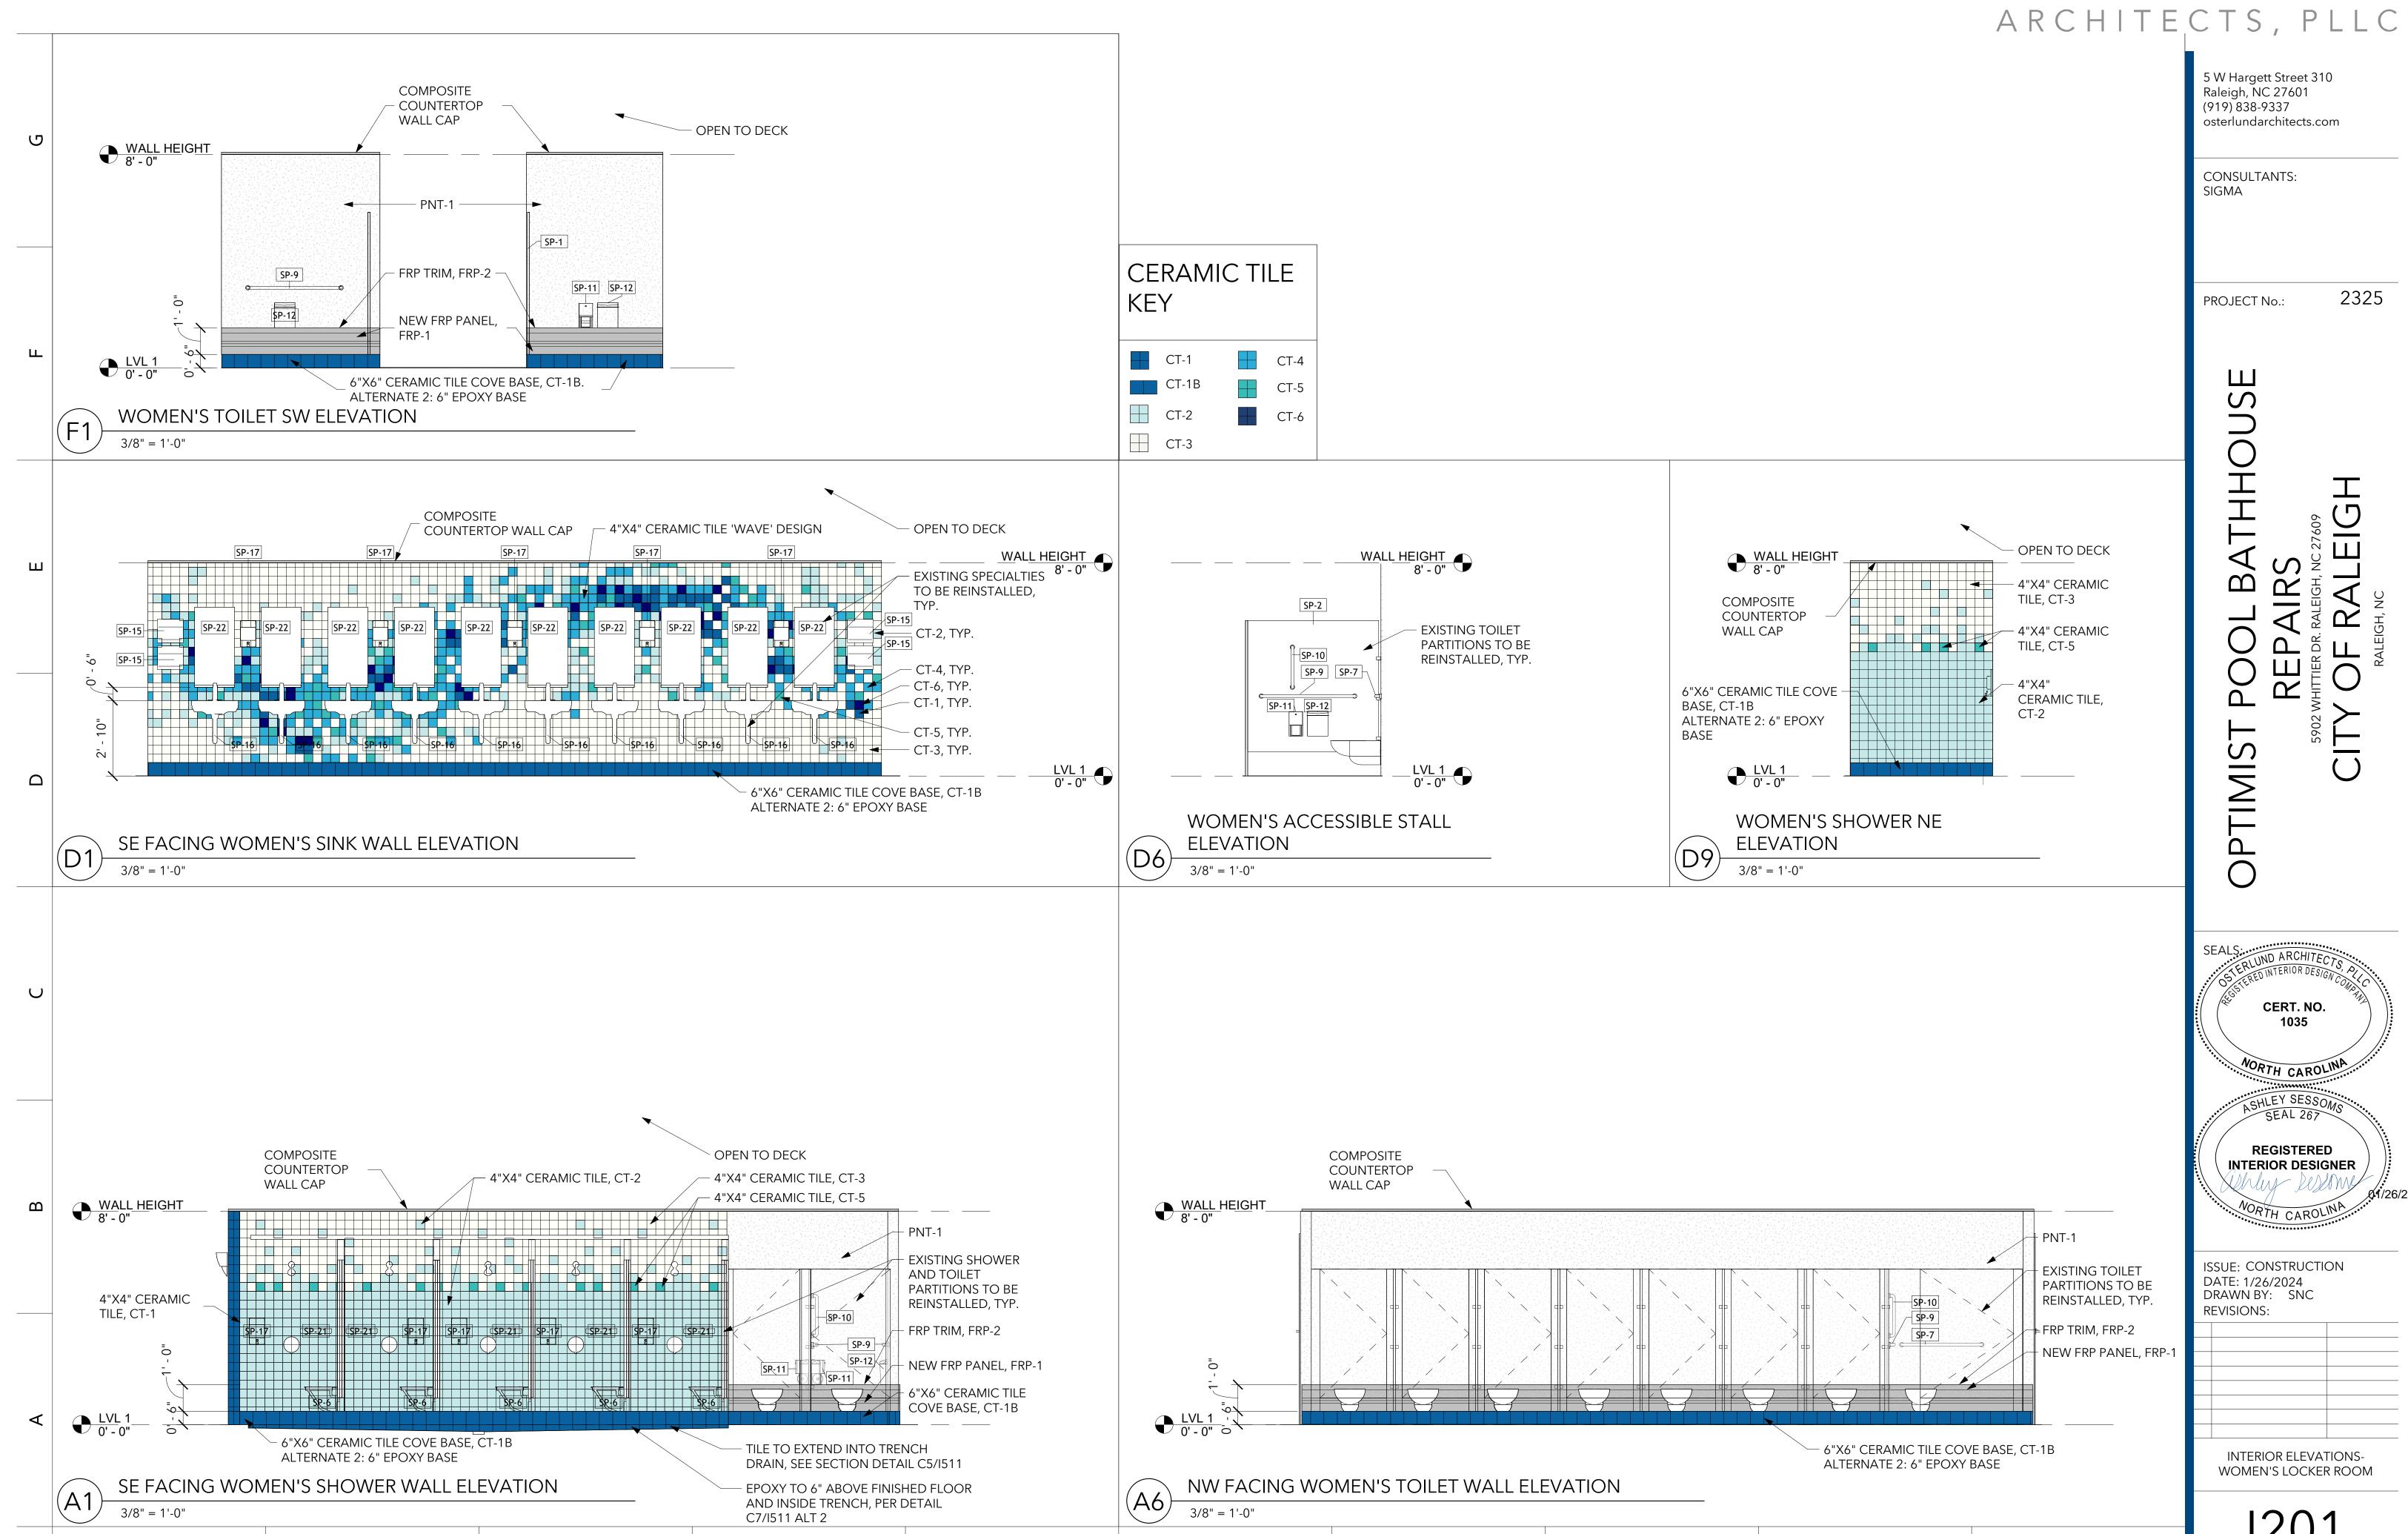


ISSUE: CONSTRUCTION DATE: 1/26/2024 DRAWN BY: SNC

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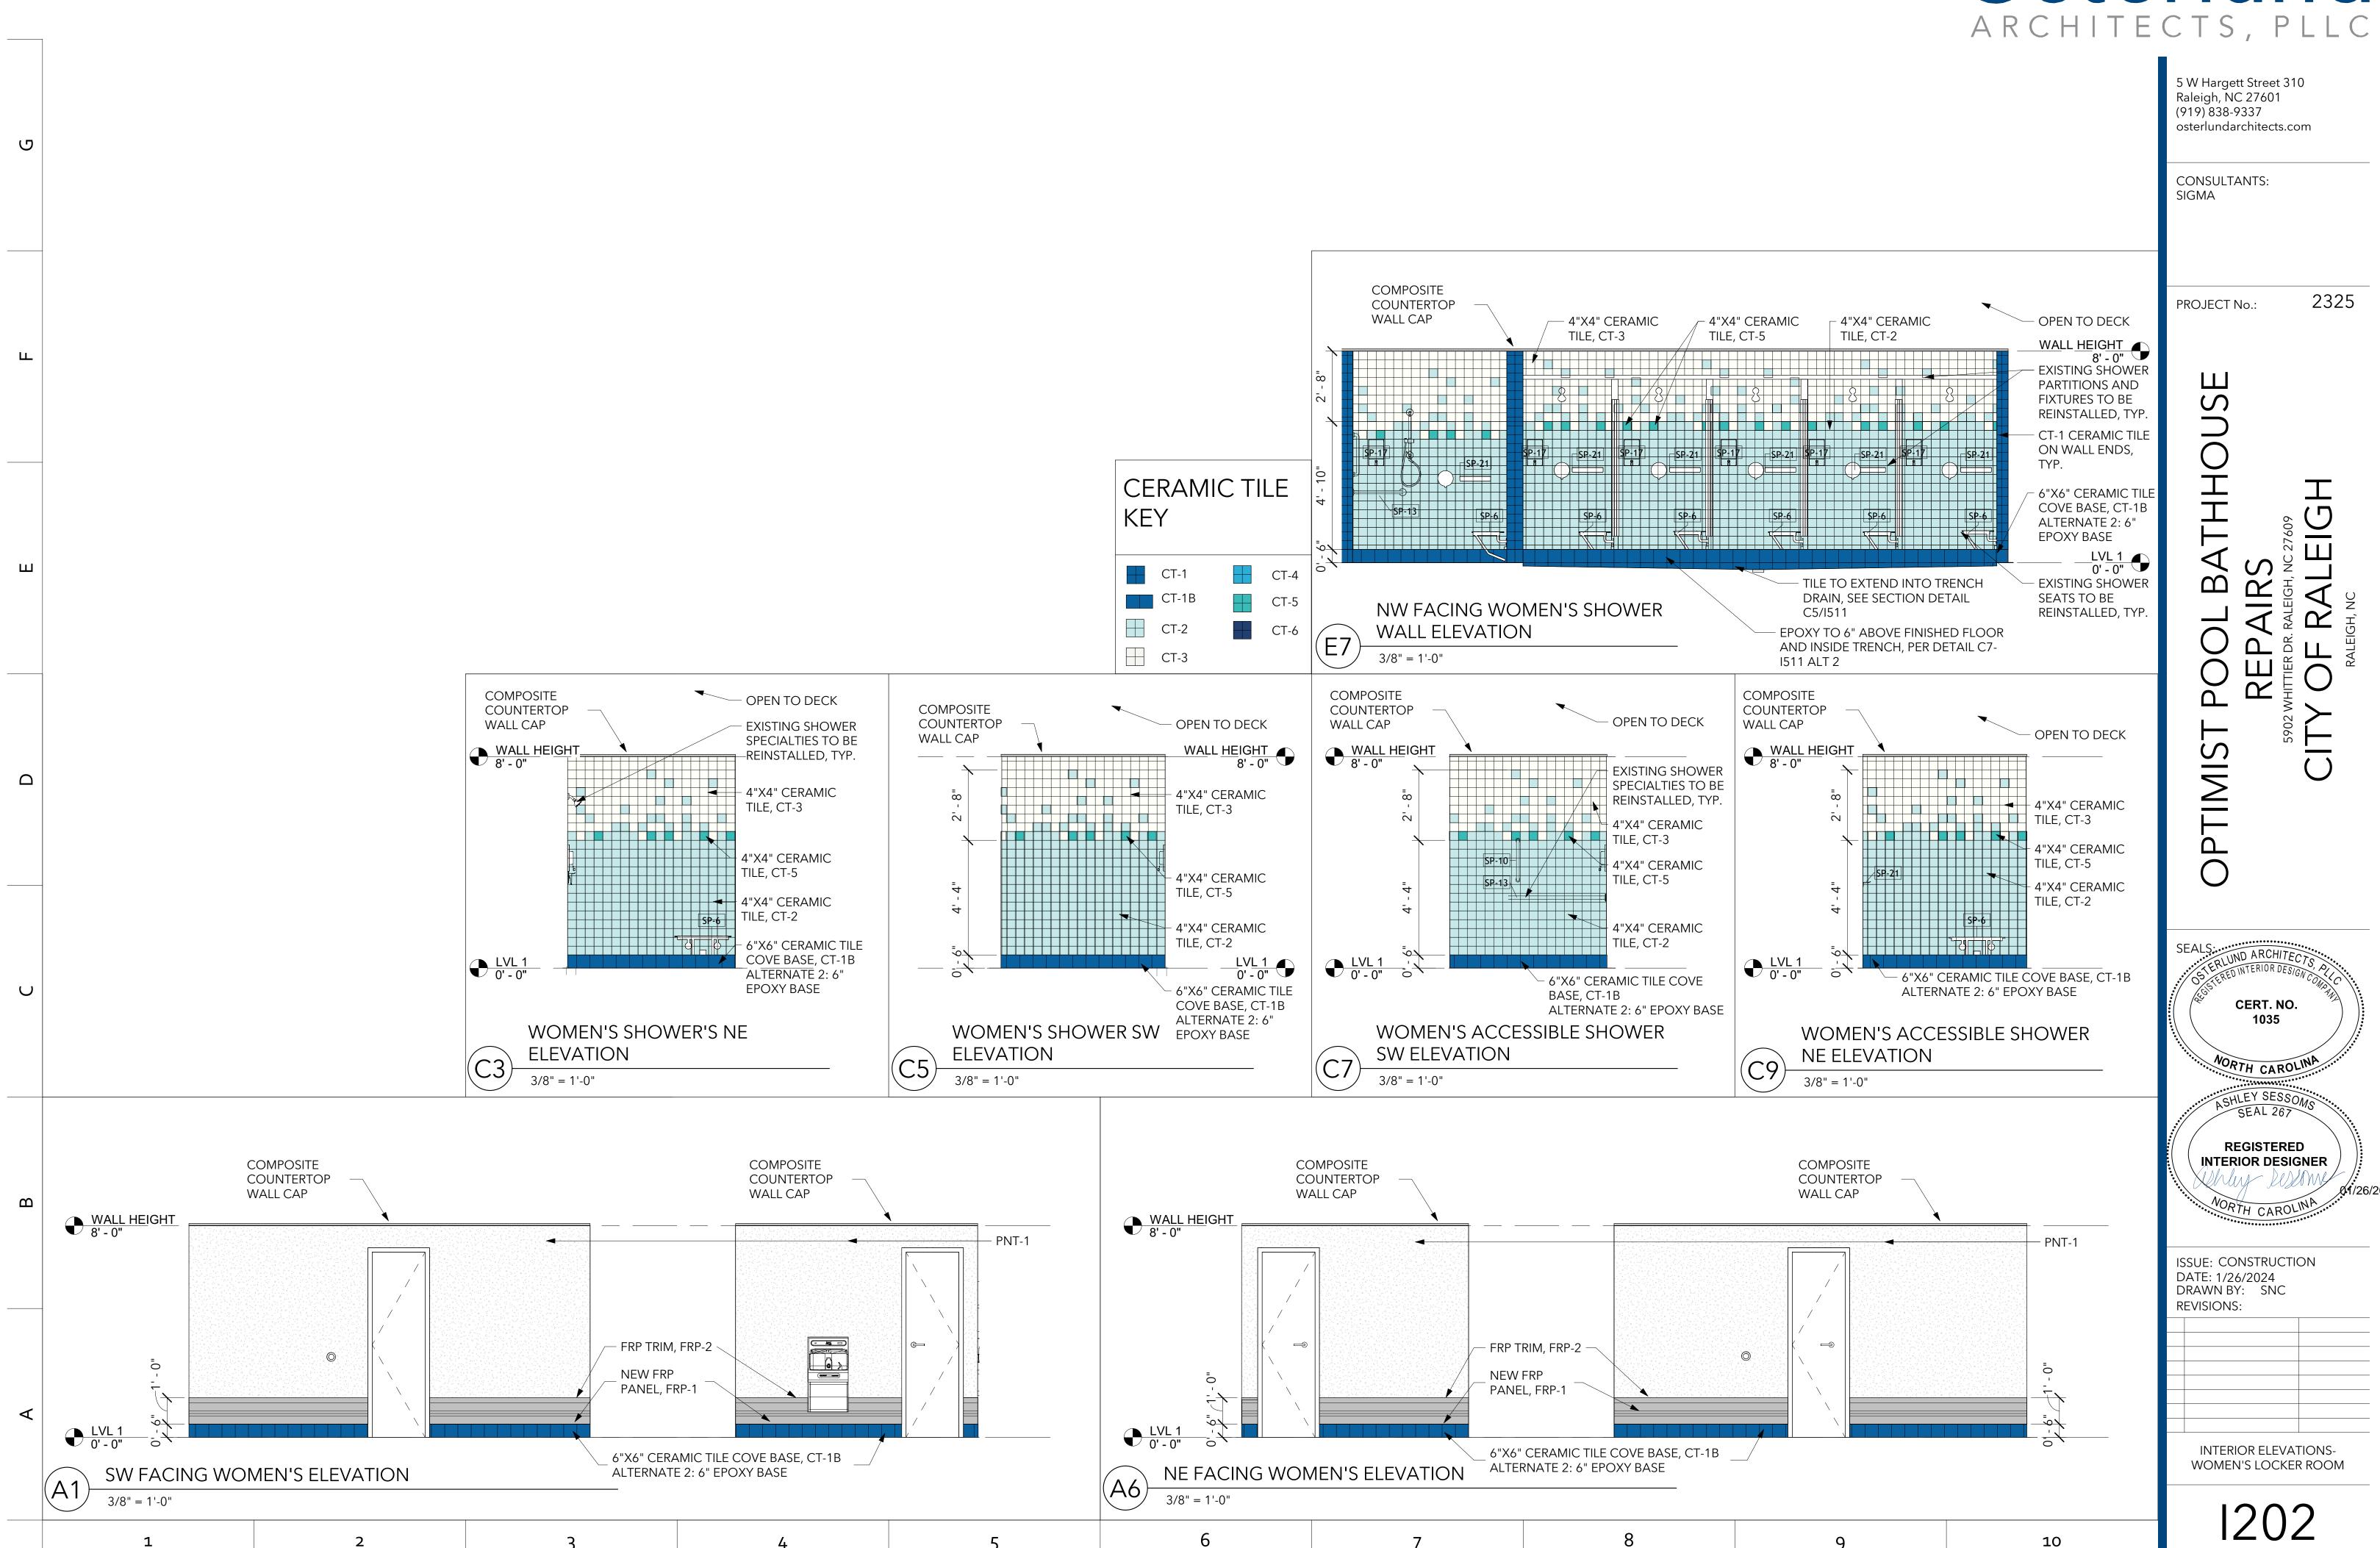
			ARCHII	ECIS, PLLC
	Position of Project:Optimist Pool Bathhouse Repairs	PERCENTAGE OF WALL OPENING CALCULATIONS FIRE SEPARATION DISTANCE (FEET) FROM PROPERTY LINES PROTECTION (%6) EXISTING- NO CHANGE LIFE SAFETY SYSTEM REQUIREMENTS Emergency Lighting: Yes Exit Signs: Yes Fire Alarm: Yes Smoke Detection Systems: Yes Carbon Monoxide Detection: No LIFE SAFETY PLAN REQUIREMENTS Life Safety Plan Sheet #: EXISTING- NO CHANGE TO LIFE SAFETY PLAN Fire and/or smoke rated wall locations (Chapter 7) Assumed and real property line locations (if not on the site plan) Exterior wall opening area with respect to distance to assumed property lines (705.8)	*EXISTING-NO CHANGE 2018 APPENDIX B BUILDING CODE SUMMARY FOR ALL COMMERCIAL PROJECTS STRUCTURAL DESIGN (PROVIDE ON THE STRUCTURAL SHEETS IF APPLICABLE) DESIGN LOADS: Importance Factors: Snow (Is) Select one Seismic (IE) Select one Live Loads: Roof psf Mezzanine psf Floor psf Ground Snow Load: psf Wind Load: Ultimate Wind Speed mph (ASCE-7) Exposure Category Select one Provide the following Seismic Design Parameters: Risk Category (Table 1604.5) Select one Spectral Response Acceleration Ss yet Site Classification (ASCE 7) Select one Site Classification (ASCE 7) Select one	5 W Hargett Street 310 Raleigh, NC 27601 (919) 838-9337 osterlundarchitects.com CONSULTANTS: SIGMA PROJECT No.: 2325
	2018 NC EXISTING BUILDING CODE: Repair Select one Select one CONSTRUCTED: (date)2008 CURRENT OCCUPANCY(S) (Ch. 3): _A-3 RENOVATED: (date) PROPOSED OCCUPANCY(S) (Ch. 3): _A-3 RISK CATEGORY (Table 1604.5): Current: [II	Occupancy Use for each area as it relates to occupant load calculation (Table 1004.1.2) Occupant loads for each area Exit sign locations (1013) Exit access travel distances (1017) Common path of travel distances (Tables 1006.2.1 & 1006.3.2(1)) Dead end lengths (1020.4) Clear exit widths for each exit door Maximum calculated occupant load capacity each exit door can accommodate based on egress width (1005.3) Actual occupant load for each exit door A separate schematic plan indicating where fire rated floor/ceiling and/or roof structure is provided for purposes of occupancy separation Location of doors with panic hardware (1010.1.10) Location of doors with delayed egress locks and the amount of delay (1010.1.9.7) Location of doors with electromagnetic egress locks (1010.1.9.9) Location of doors equipped with hold-open devices Location of emergency escape windows (1030) The square footage of each fire area (202) The square footage of each smoke compartment for Occupancy Classification I-2 (407.5) Note any code exceptions or table notes that may have been utilized regarding the items above	Data Source: Select one Basic structural system Select one Analysis Procedure: Select one Architectural, Mechanical, Components anchored? Select one LATERAL DESIGN CONTROL: Select one SOIL BEARING CAPACITIES: Select one psf Pile size, type, and capacity	ATHHOUSE czz609 EIGH
	ALLOWABLE AREA Primary Occupancy Classification(s): Assembly - A-3 Select one Select on	ACCESSIBLE DWELLING UNITS (SECTION 1107) UNIT CLASSIFICATION UNITS REQUIRED ROVIDED ROVIDED REQUIRED ROVIDED REQUIRED ROVIDED REQUIRED ROVIDED ROVIDED REQUIRED ROVIDED REQUIRED ROVIDED	*EXISTING-NO CHANGE 2018 APPENDIX B BUILDING CODE SUMMARY FOR ALL COMMERCIAL PROJECTS MECHANICAL DESIGN (PROVIDE ON THE MECHANICAL SHEETS IF APPLICABLE) MECHANICAL SUMMARY MECHANICAL SYSTEMS, SERVICE SYSTEMS AND EQUIPMENT Thermal Zone winter dry bulb: summer dry bulb: sum	OPTIMIST POOL BAREPAIRS 5902 WHITTIER DR. RALEIGH, NG CITY OF RALE RALEIGH, NC
	ALLOWABLE HEIGHT ALLOWABLE SHOWN ON PLANS CODE REFERENCE	*EXISTING-NO CHANGE *ENERGY SUMMARY ENERGY REQUIREMENTS: The following data shall be considered minimum and any special attribute required to meet the energy code shall also be provided. Each Designer shall furnish the required portions of the project information for the plan data sheet. If performance method, state the annual energy cost for the standard reference design vs annual energy cost for the proposed design. Existing building envelope complies with code: Select one	description of unit: heating efficiency: cooling efficiency: size category of unit: Boiler Size category. If oversized, state reason.: Chiller Size category. If oversized, state reason.: List equipment efficiencies: *SEE ELECTRICAL SHEETS 2018 APPENDIX B BUILDING CODE SUMMARY FOR ALL COMMERCIAL PROJECTS ELECTRICAL DESIGN (PROVIDE ON THE ELECTRICAL SHEETS IF APPLICABLE) ELECTRICAL SUMMARY ELECTRICAL SUMMARY ELECTRICAL SYSTEM AND EQUIPMENT	SEALS: ARCHITECTS PLLC ARCHITECTS PLLC RECHITECTS PLLC
	Bearing Walls	Exempt Building: Select one Method of Compliance: Select one	Method of Compliance: Select one Lighting schedule (each fixture type) lamp type required in fixture number of lamps in fixture ballast type used in the fixture number of ballasts in fixture total wattage per fixture total wattage specified vs. allowed (whole building or space by space) total exterior wattage specified vs. allowed Additional Efficiency Package Options (When using the 2018 NCECC; not required for ASHRAE 90.1) C406.2 More Efficient HVAC Equipment Performance C406.3 Reduced Lighting Power Density C406.4 Enhanced Digital Lighting Controls C406.5 On-Site Renewable Energy C406.6 Dedicated Outdoor Air System C406.7 Reduced Energy Use in Service Water Heating	ISSUE: CONSTRUCTION DATE: 1/26/2024 DRAWN BY: KO REVISIONS: 1 PERMIT COMMENTS 01/19/2024
		Floors slab on grade Description of assembly: U-Value of total assembly: R-Value of insulation: Horizontal/vertical requirement: slab heated: 2018 NC Administrative Code and Policies Revised 6/15/2020	2018 NC Administrative Code and Policies Revised 6/15/2020	CODE SUMMARY
2 3 4	5 6	7 8	9 10	G001

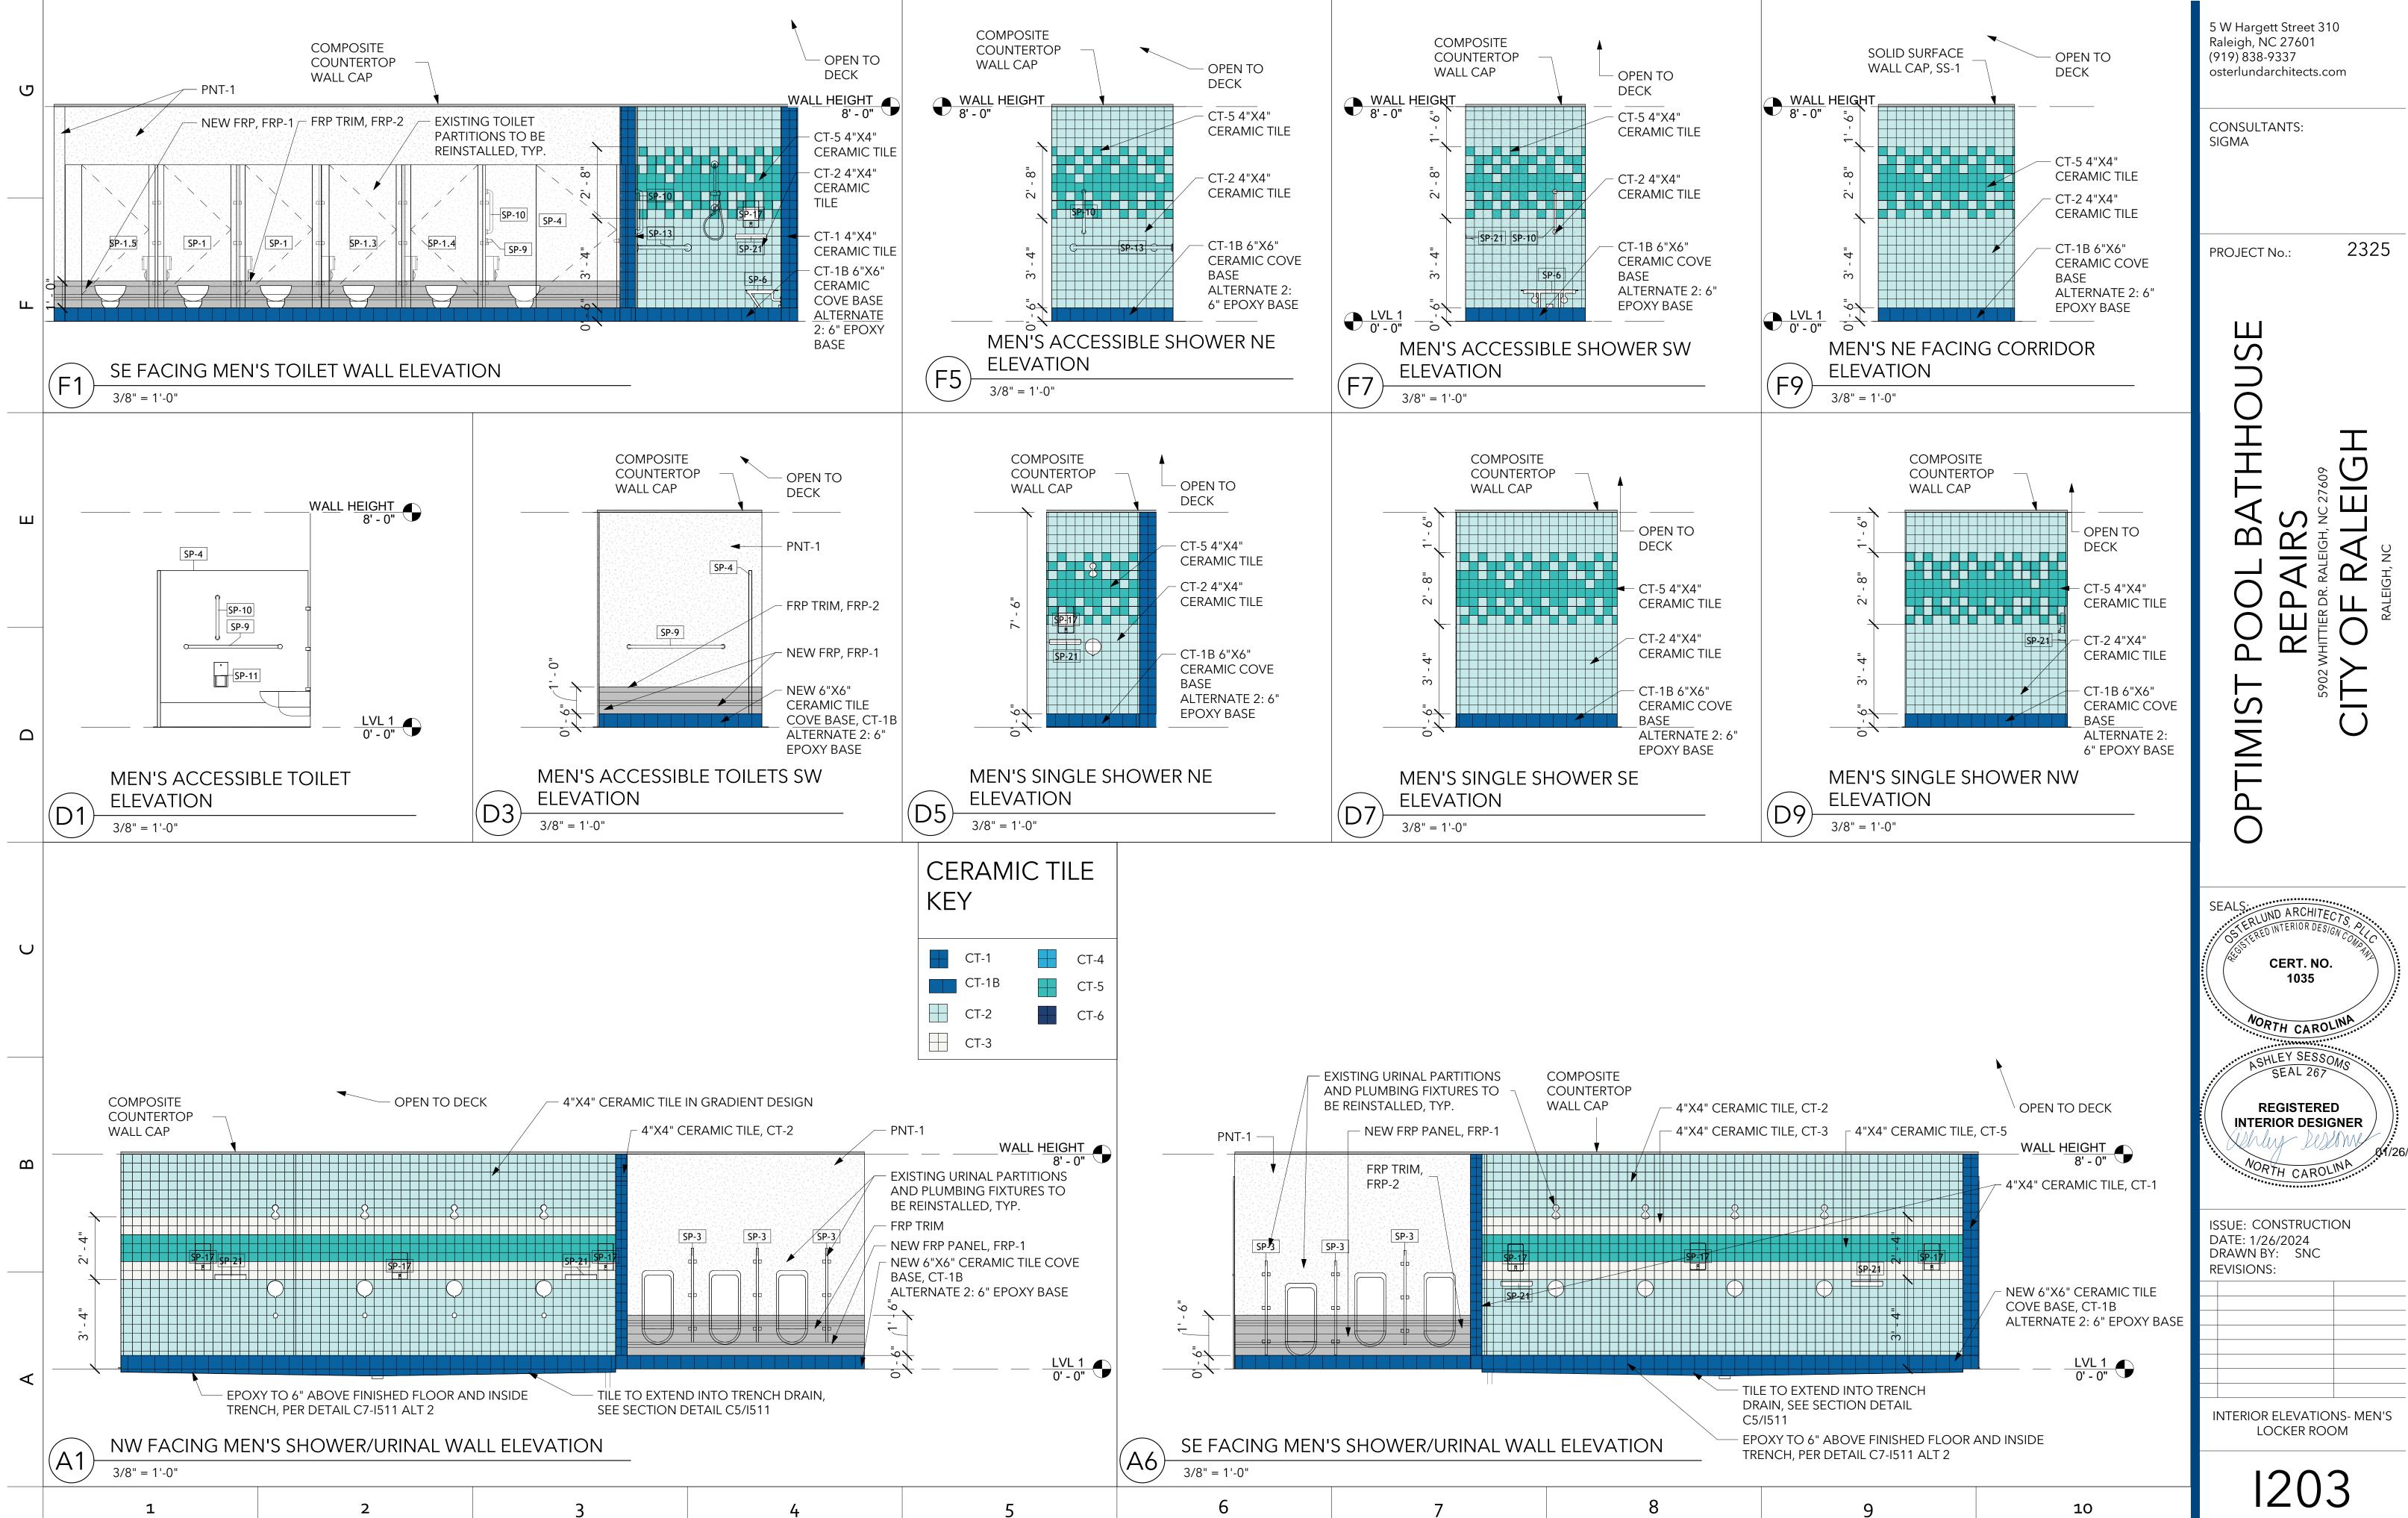




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3/8" = 1'-0"

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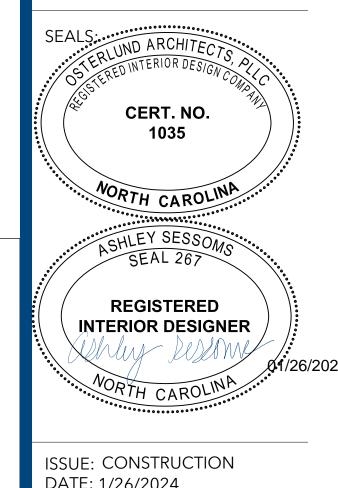
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CONSULTANTS:





ISSUE: CONSTRUCTION DATE: 1/26/2024 DRAWN BY: SNC **REVISIONS:**

COMPOSITE COUNTERTOP

WALL CAP

WALL HEIGHT 8' - 0"

<u>LVL 1</u> 0' - 0"

ELEVATION

3/8" = 1'-0"

NW FACING MEN'S SINK WALL

- 4"X4" CERAMIC TILE 'WAVE' DESIGN

OPEN TO DECK

CT-5, TYP.

– CT-3, TYP.

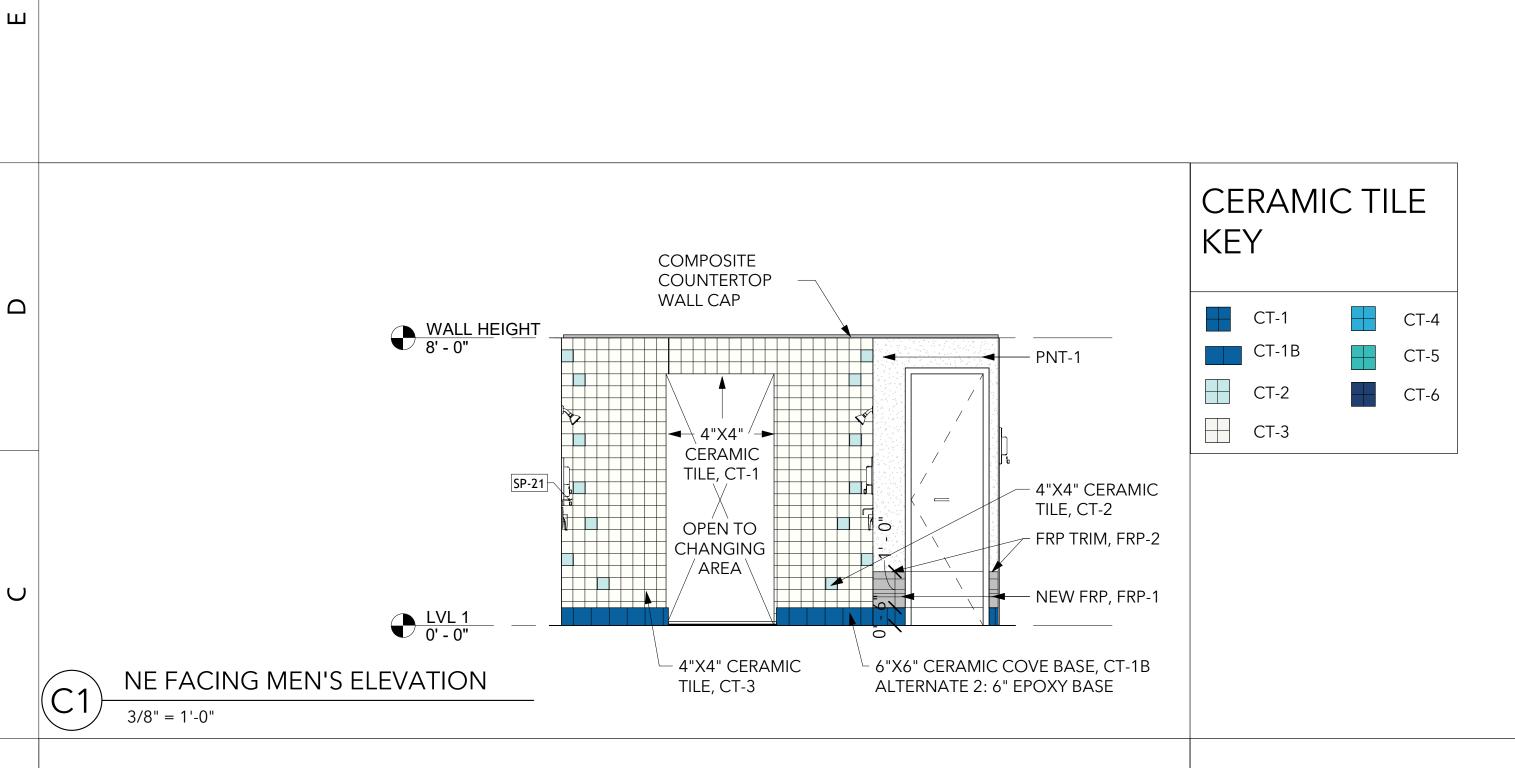
- EXISTING SPECIALTIES TO BE REINSTALLED,

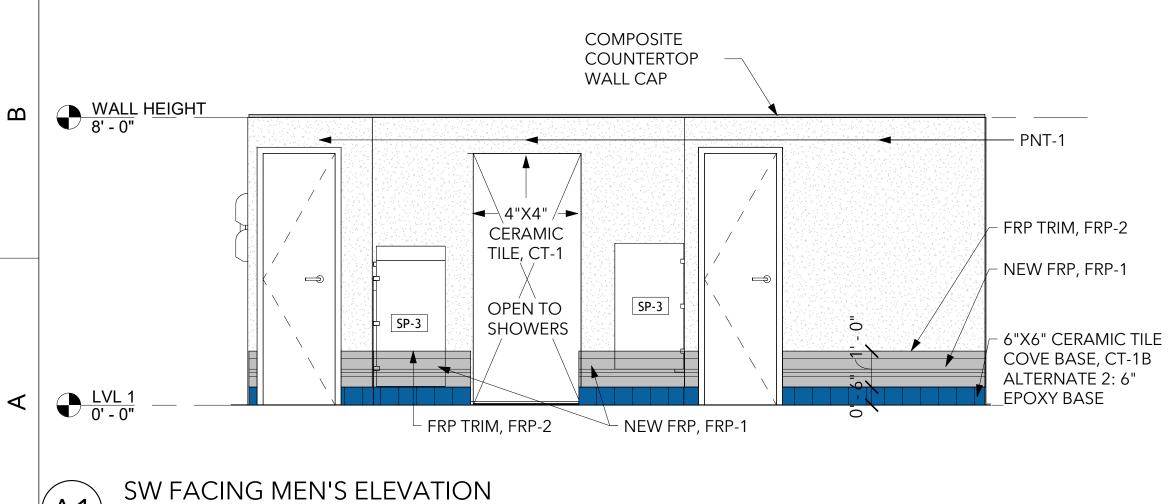
- 6"X6" CERAMIC TILE COVE BASE,

10

ALTERNATE 2: 6" EPOXY BASE

INTERIOR ELEVATIONS- MEN'S LOCKER ROOM





27' - 5"

3' - 5"

SP-12

SP-5 SP-5

MECH. CHASE

104F

SP-5

3' - 8"

3' - 6"

5' - 9"

SP-12

SP-11.

104A

MECH. CHASE

SP-12

SP-1,1

SP-5

18' - 10"

3' - 8"

3' - 1"

SP-12

SP-11

SP-18

SP-7

104C

4' - 0"

A1 1202

SP-12 SP-11 SP-10

SHOWERS

104B

3' - 8"

REPLACE CAULK AT BOTTOM OF

ALTERNATE 1:

REPAINT SHELVING TO

MATCH NEW PNT-1

ALIGN EPOXY FLOOR

EXISTING WALL CORNER

TRANSITION WITH

CONCRETE/TERRAZZO, SEE DETAIL C9/I511

CHANGING AREA

104D

Â' - 11".

(1202) A6

WOMEN'S LOCKER ROOM

104

3/8" = 1'-0"

SP-18

SP-12

₩SP-11

SP-9

SP-10

SP-11

SP-12

SP-9

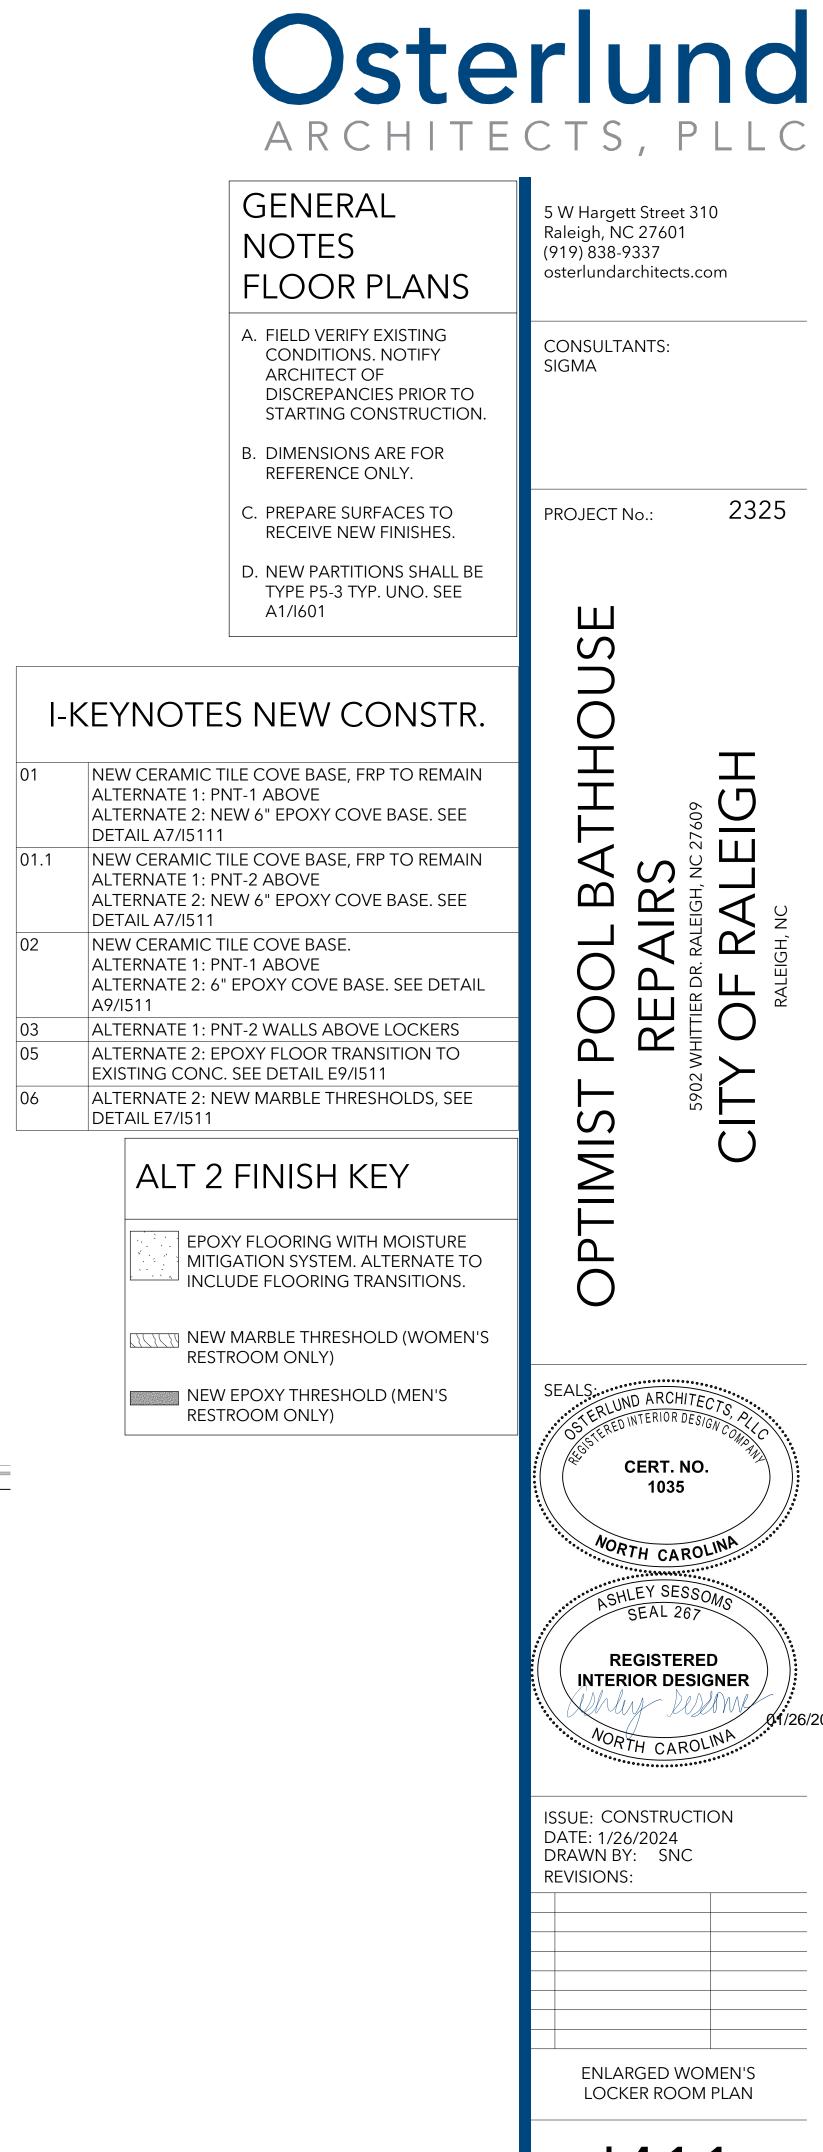
SP-13

C7 1202 C9-.

6' - 3 3/4"

ENLARGED WOMEN'S LOCKER ROOM PLAN

SP-12



10

(03)-



- A. FIELD VERIFY EXISTING CONDITIONS. NOTIFY ARCHITECT OF DISCREPANCIES PRIOR TO STARTING CONSTRUCTION.
- B. DIMENSIONS ARE FOR REFERENCE ONLY.
- C. PREPARE SURFACES TO RECEIVE NEW FINISHES.
- D. NEW PARTITIONS SHALL BE TYPE P5-3 TYP. UNO. SEE A1/I601

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PROJECT No.:

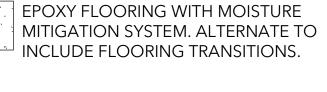
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2325

ALTERNATE 1: PNT-3 ABOVE ALTERNATE 2: NEW 6" EPOXY COVE BASE. SEE DETAIL A7/I511

- NEW CERAMIC TILE COVE BASE. ALTERNATE 1: PNT-1 ABOVE ALTERNATE 2: 6" EPOXY COVE BASE. SEE DETAIL A9/I511
- ALTERNATE 1: PNT-3 WALLS ABOVE
- DETAIL E9/I511
- ALTERNATE 2: BUILD UP EPOXY ALL THE WAY ACROSS OPENING. USE CONTRASTING COLOR

- NEW MARBLE THRESHOLD (WOMEN'S
- NEW EPOXY THRESHOLD (MEN'S

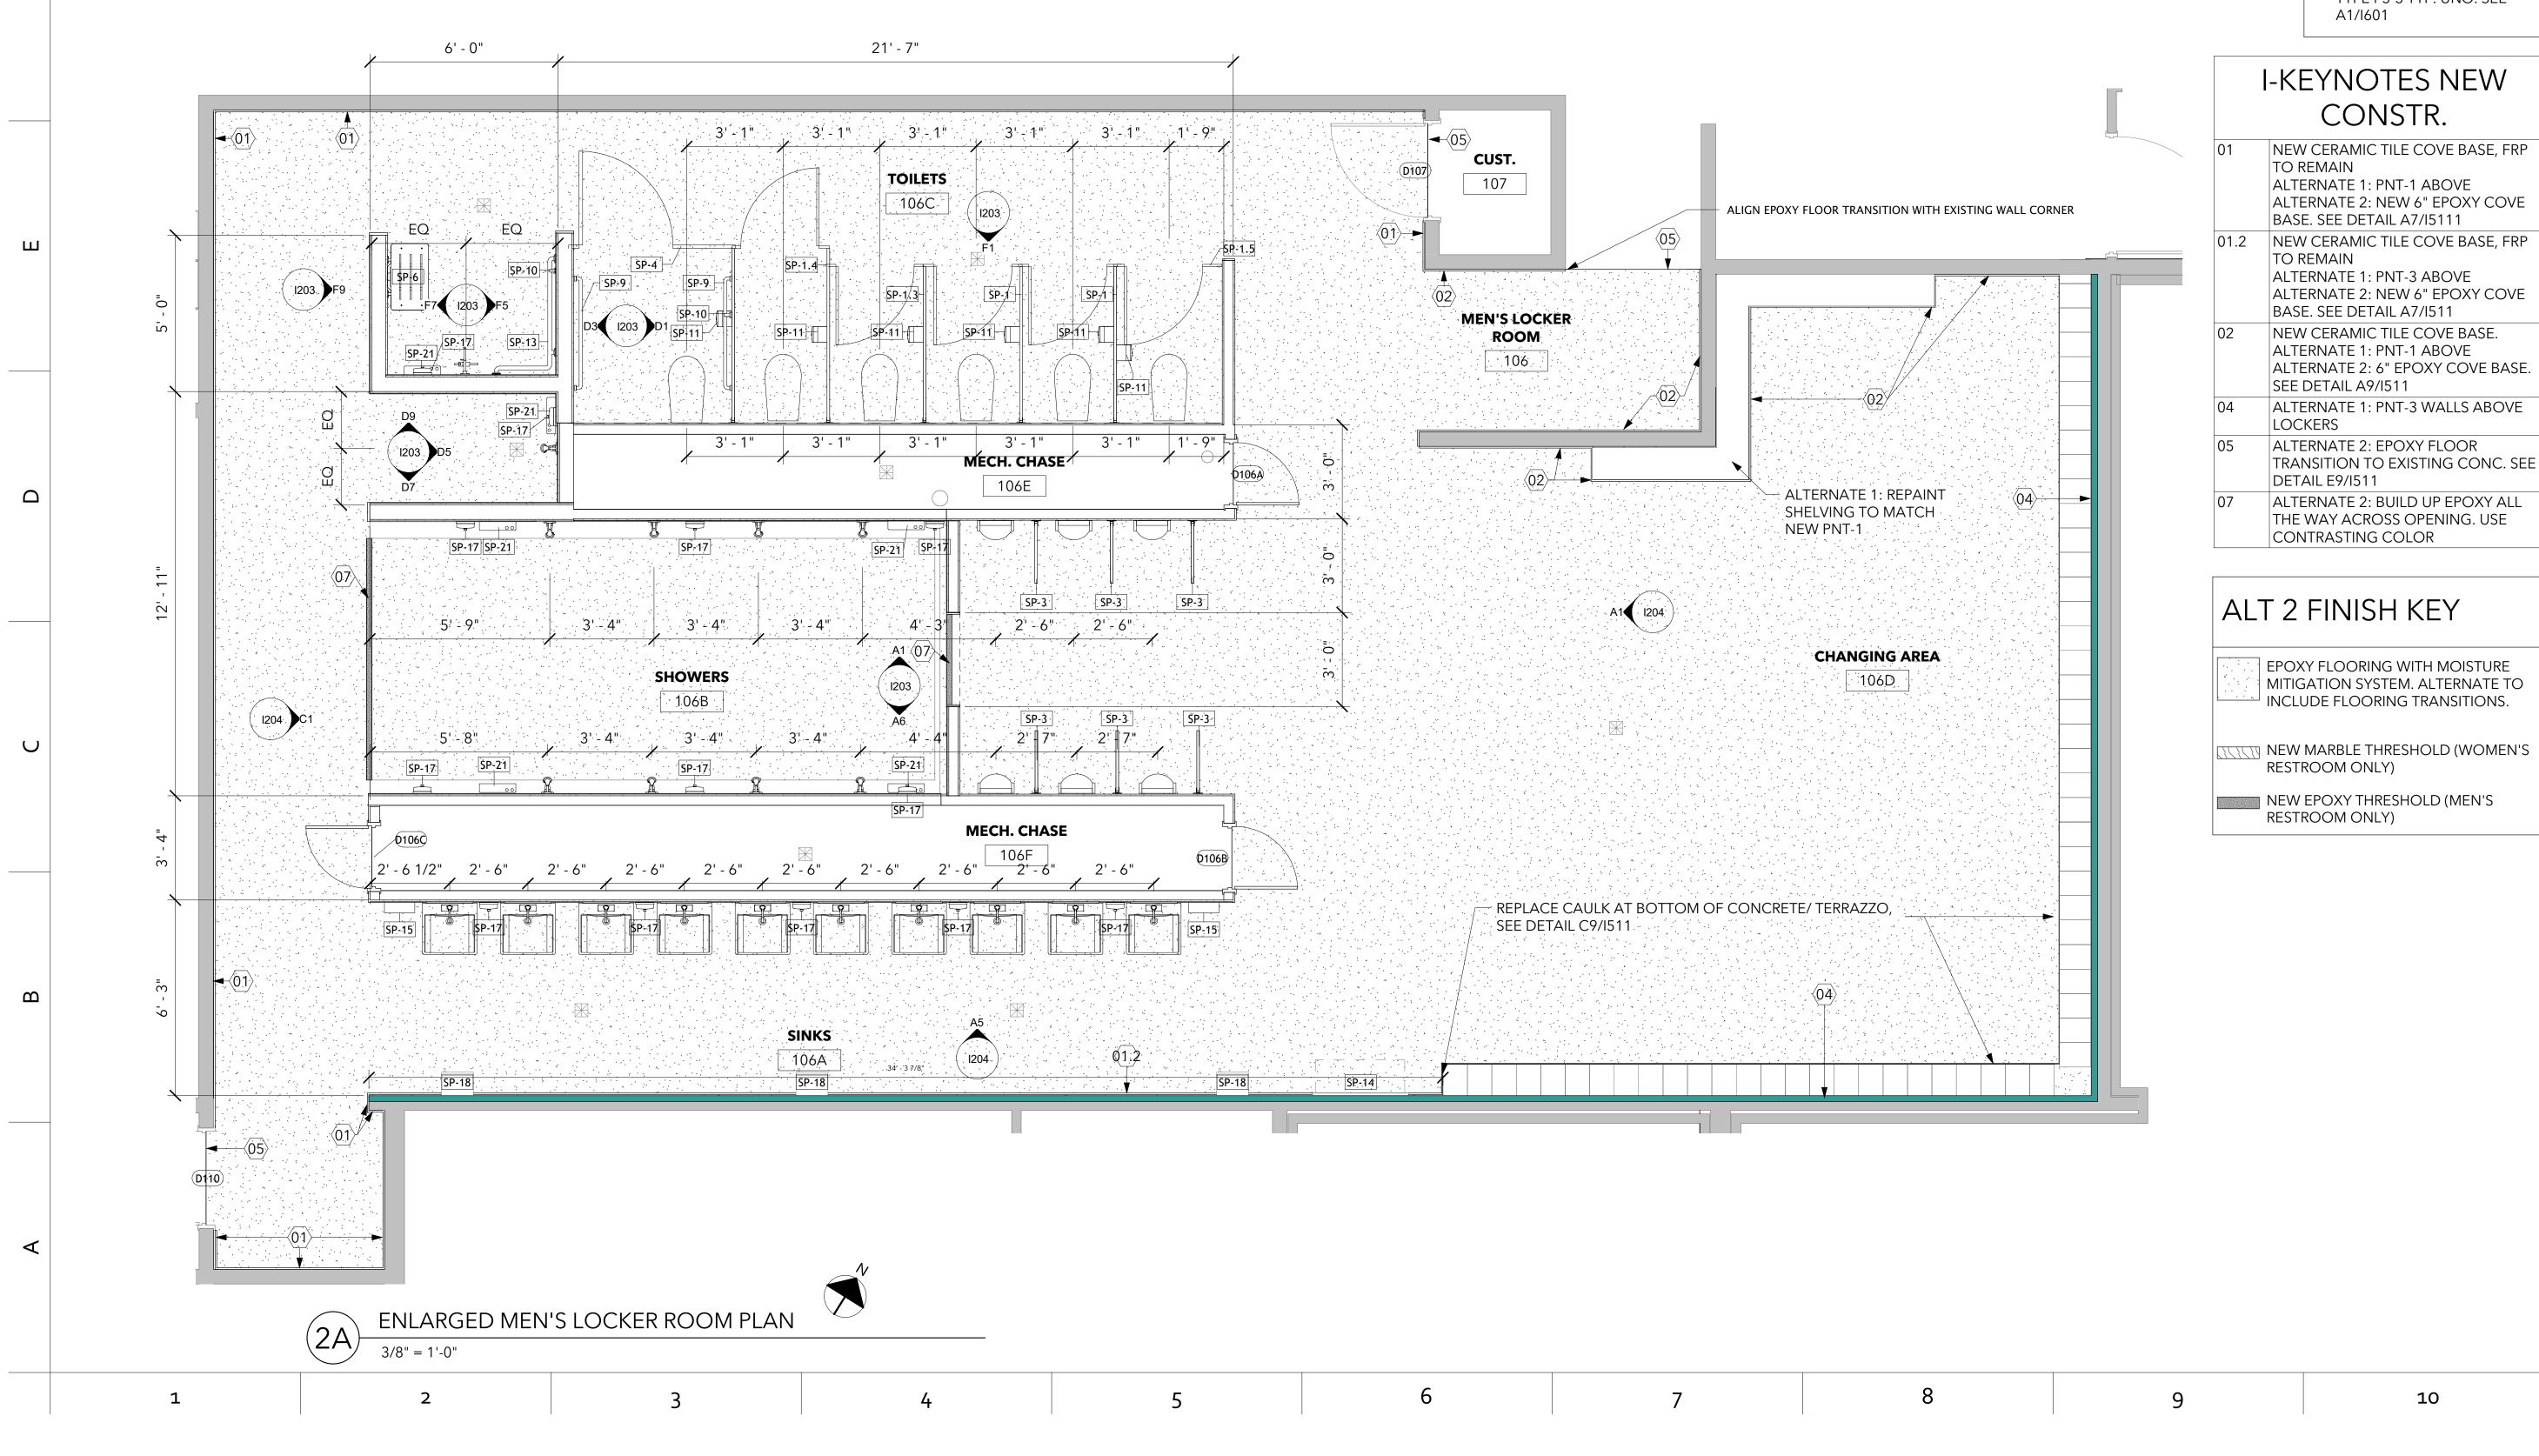


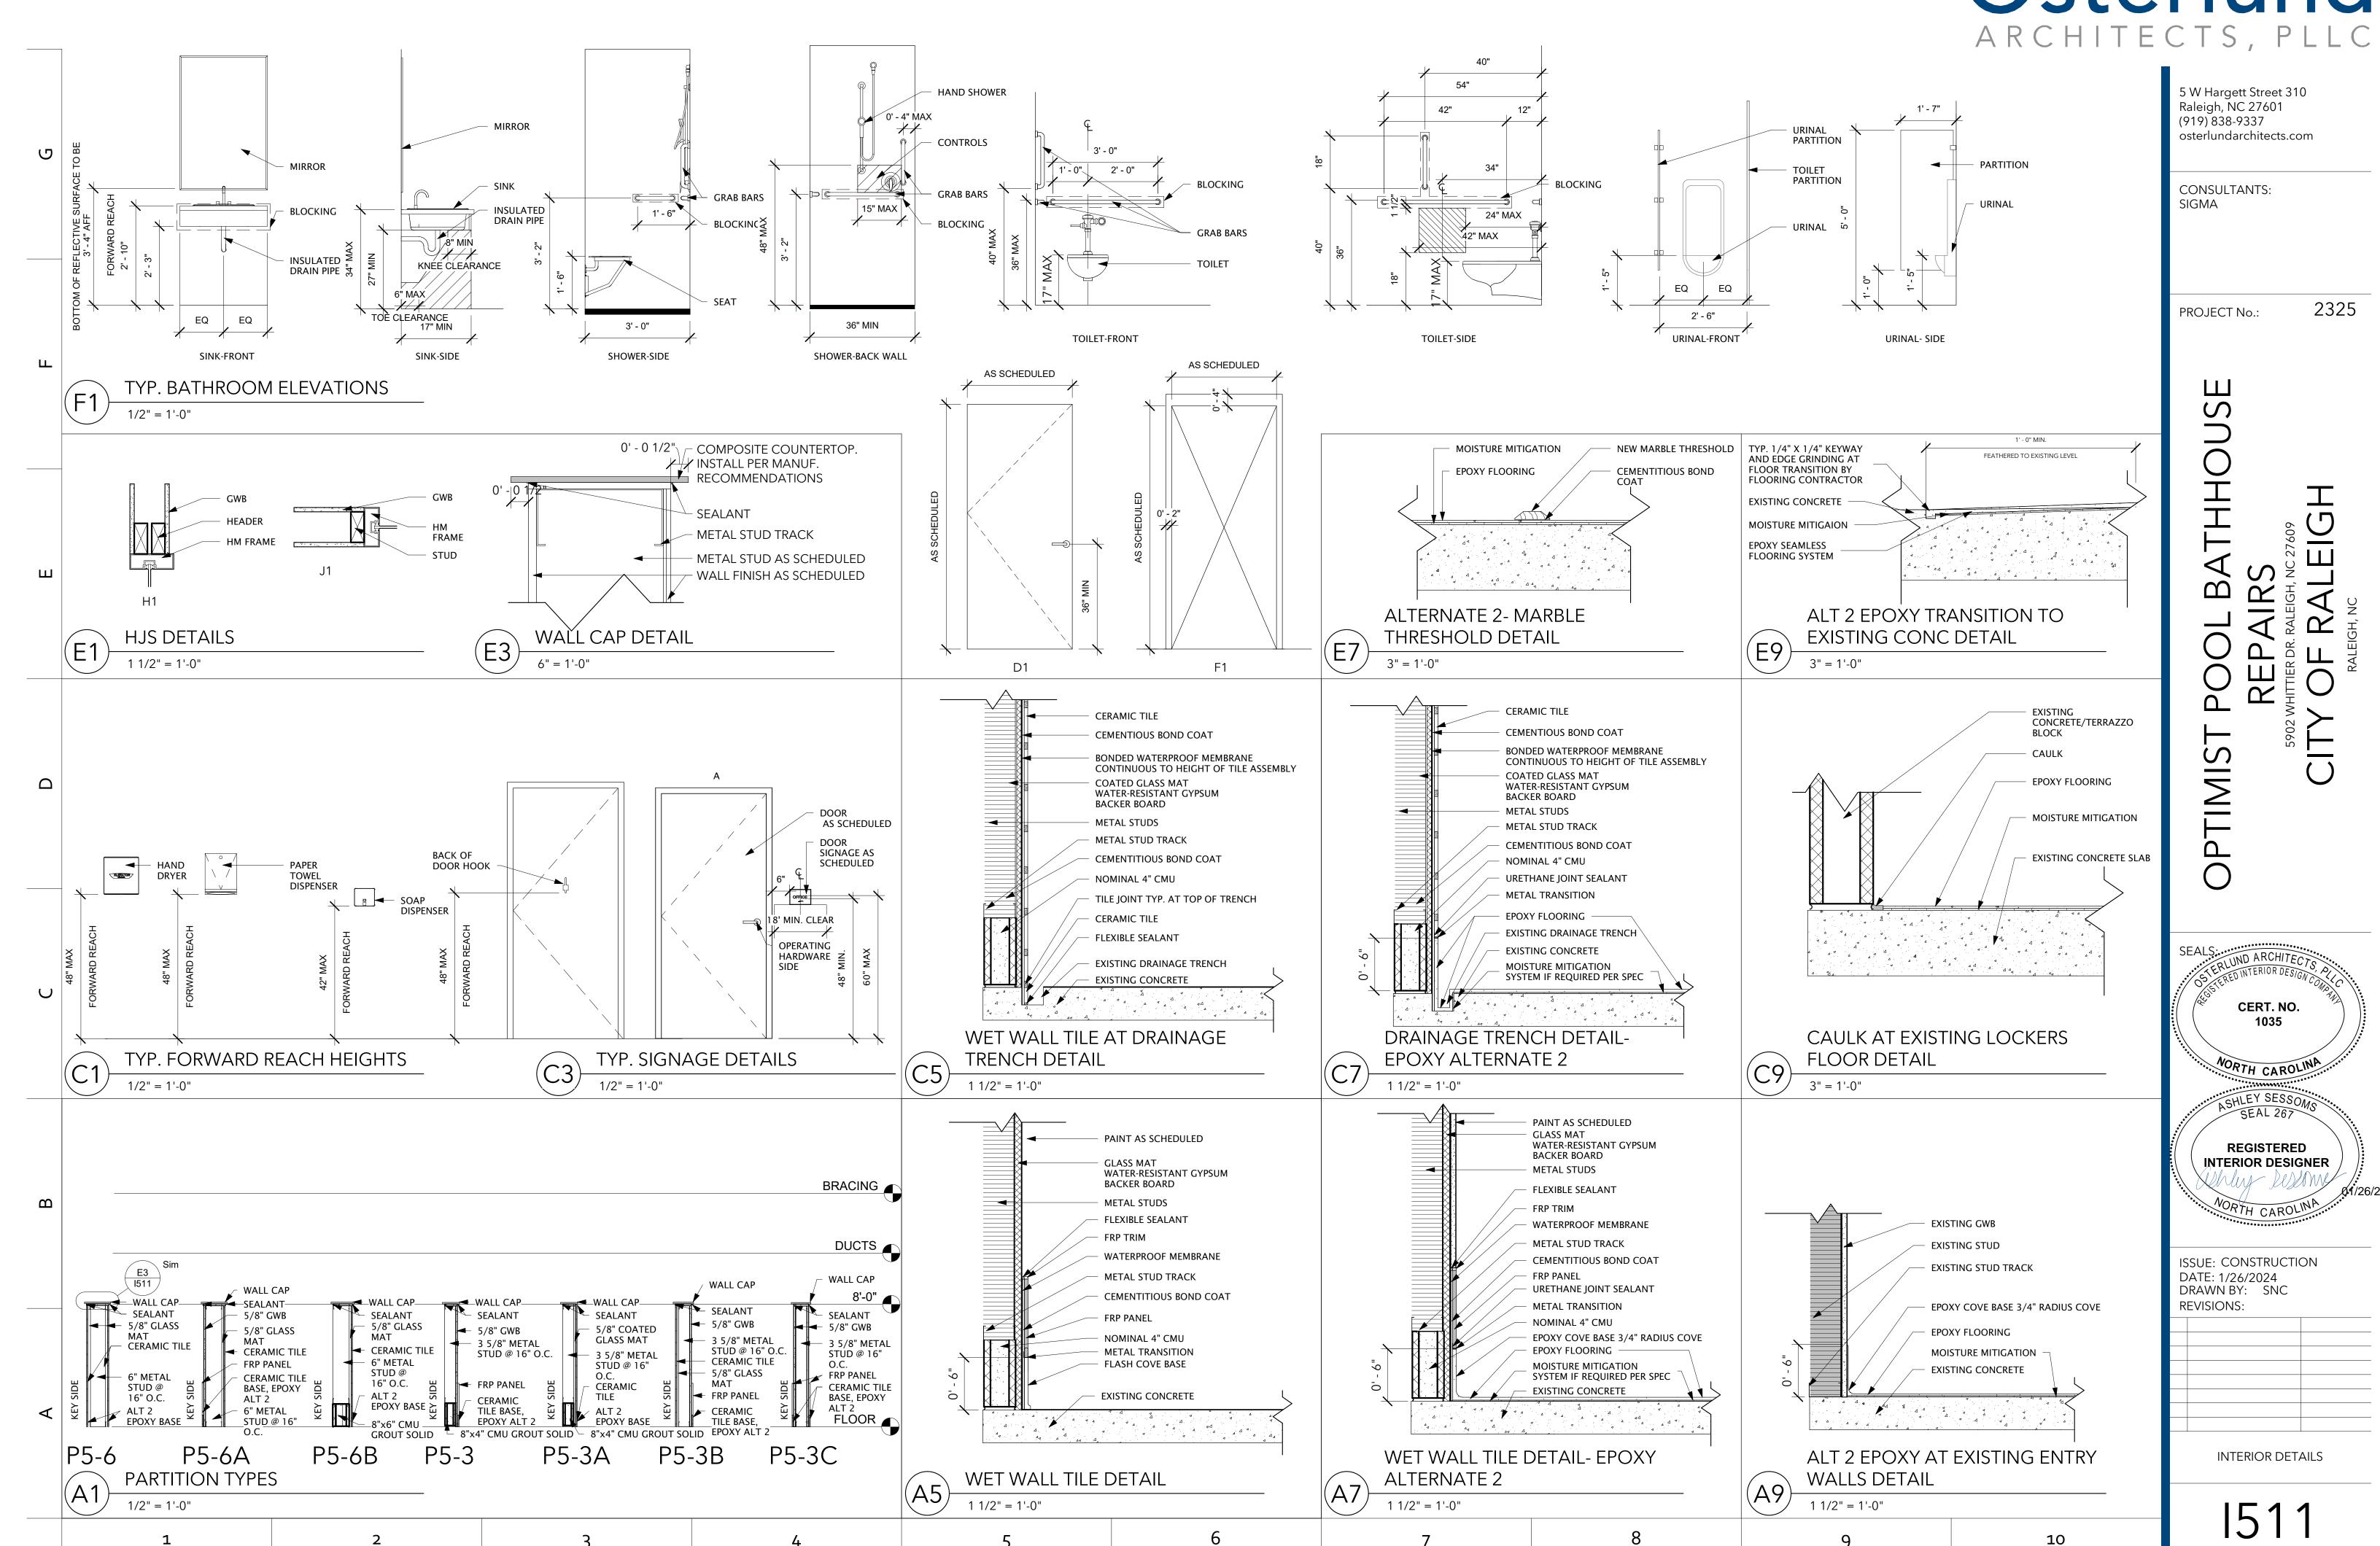
RESTROOM ONLY)

STERLUND ARCHITECTS CERT. NO. 1035 NORTH CAROLIN SEAL 267 **REGISTERED** INTERIOR DESIGNER NORTH CAROLINA

ISSUE: CONSTRUCTION DATE: 1/26/2024 DRAWN BY: SNC **REVISIONS:**

ENLARGED MEN'S LOCKER **ROOM PLAN**





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CONSULTANTS: SIGMA

PROJECT No.:

HARDWARE

104E

104E

104F

104F

106E

106F

NOTES

SEE ELEVATION D1/I201 FOR TILE DESIGN

SEE ELEVATIONS ON I201 AND I202 FOR

TILE DESIGNS

SEE ELEVATION A5/I204 FOR TILE DESIGN

TILE DESIGN

NOTES

FIRE | SET | KEYSIDE

Α

Α

Α

| A |

Α

A 106F

RATING NO. RM NO

2325

ATHHOUS

										CEALC.
107	CUST.	EXISTING CONCRETE	-	-	-	-	-			SEALS: ARCHITECTS
										STERED INTERIOR DESIGN COMPA
										CERT. NO.
		SP	ECIALTY E	EQUIPME	ENT SCH	IEDULE				1035
TYP	PE MARK			NAME				PROVIDED BY	INSTALLED BY	i.i.
SP-1		36" x 56" TOILET COMPARTMEN	NT				SAL	VAGED	GC	· · · · · · · · · · · · · · · · · · ·
SP-1.1		34" x 66" TOILET COMPARTMEN	NT				SAL	VAGED	GC	NORTH CAROLINA
SP-1.2		34" x 66" OUT-SWING TOILET C	OMPARTMENT				SAL	VAGED	GC	ASHLEY SESSOMS
SP-1.3		34"X60" TOILET COMPARTMEN	T				SAL	VAGED	GC	SEAL 267
SP-1.4		34"X67" TOILET COMPARTMEN	T				SAL	VAGED	GC	
SP-1.5		38" X 60" TOILET COMPARTME	NT				SAL	VAGED	GC	REGISTERED
SP-1.6		36" x 66" OUT-SWING TOILET C	OMPARTMENT				SAL	VAGED	GC	INTERIOR DESIGNER
SP-1.7		37" x 66" TOILET COMPARTMEN	NT				SAL	VAGED	GC	- I I XUNUY RUM MY
SP-2		60" x 60" TOILET COMPARTMEN	NT				SAL	VAGED	GC	NODE THE STATE OF
SP-3		23" x 42" URINAL SCREEN					SAL	VAGED	GC	NORTH CAROLINA
SP-4		60" x 67" TOILET COMPARTMEN	NT				SAL	VAGED	GC	
SP-5		6' L SHOWER PARTITION					SAL	VAGED	GC	ICCLIE, CONSTRUCTION
SP-6		ACCESSIBLE SHOWER SEAT					SAL	VAGED	GC	ISSUE: CONSTRUCTION DATE: 1/26/2024
SP-7		36" HORIZONTAL BACK GRAB E	BAR				SAL	VAGED	GC	DRAWN BY: SNC
SP-9		42" SIDE GRAB BAR					SAL	VAGED	GC	REVISIONS:
SP-10		NEW 18" VERTICAL GRAB BAR					GC		GC	
SP-11		TOILET PAPER DISPENSER					SAL	VAGED	GC	
SP-12		NEW SANITARY NAPKIN DISPO	SAL				GC		GC	
SP-13		L SHAPED GRAB BAR					SAL	VAGED	GC	
SP-14		BABY CHANGING STATION					EXIS	ST. TO REMAIN	GC	
SP-15		HAND DRYER					SAL	VAGED	GC	
SP-16		INSULATED DRAIN PIPE					SAL	VAGED	GC	
SP-17		SOAP DISPENSER						VAGED	GC	INITEDIOD COLIEDIU EC
SP-18		PAPER TOWEL DISPENSER						ST. TO REMAIN	EXIS. TO REMAIN	INTERIOR SCHEDULES
SP-21		METAL SHELF 14" L X 2"H X 3 3/					GC		GC	
SP-22		NEW MIRROR W/ SHELF 18"X36)				GC		GC	1 / 0 /

DOOR AND FRAME SCHEDULE

MATL

НМ

ROOM FINISH SCHEDULE

PNT-2

PNT-1, FRP-1

PNT-2

CERAMIC TILE

F1

F1

F1

F1

F1

F1

PNT-1, FRP-1

PNT-2

PNT-3

EL GLZ

D1

D1

D1

D1

D1

D1

D1

FRAME

WALLS

CERAMIC TILE | CERAMIC TILE | CERAMIC TILE | CERAMIC TILE

DETAIL

J1

J1

J1

J1

J1

W

PNT-1, FRP-1

CERAMIC TILE | CERAMIC TILE | CERAMIC TILE | SEE ELEVATIONS ON 1203 AND 1204 FOR

_

-

GLZ HEAD JAMB SILL

H1

H1

H1

H1

H1

H1

CERAMIC TILE

PNT-1, FRP-1 | PNT-1, FRP-1 | PNT-1, FRP-1

PNT-3

DOOR

W

MARK

D104A

D104B

D104C

D104D

D106A

D106B

D106C

ROOM NAME

SINKS

SHOWERS

TOILETS

MECH. CHASE

MECH. CHASE

CUST.

SHOWERS

TOILETS

MECH. CHASE

MECH. CHASE

ROOM NO

104A

104B

104C

104D

104E

104F

105

106A

106B

106C

106E

106F

SIZE

HT

2' - 0" 7' - 0" 0' - 1"

2' - 0" 7' - 0" 0' - 1"

2' - 0" 7' - 0" 0' - 1"

2' - 0" 7' - 0" 0' - 1"

2' - 0" 7' - 0" 0' - 1"

2' - 0" 7' - 0" 0' - 1"

2' - 0" 7' - 0" 0' - 1"

FLOOR

CHANGING AREA EXISTING CONC / ALT 2: EPOXY SEE FINISH PLAN

EXISTING CONCRETE EXISTING CONCRETE

EXISTING CONCRETE

CHANGING AREA EXISTING CONC / ALT 2: EPOXY SEE FINISH PLAN

EXISTING CONCRETE

EXISTING CONCRETE

EXISTING CONC / ALT 2: EPOXY CT-1B / ALT 2:

EXISTING CONC / ALT 2: EPOXY CT-1B / ALT 2:

EXISTING CONC / ALT 2: EPOXY CT-1B / ALT 2:

EXISTING CONC / ALT 2: EPOXY CT-1B / ALT 2:

EXISTING CONC / ALT 2: EPOXY CT-1B / ALT 2:

EXISTING CONC / ALT 2: EPOXY CT-1B / ALT 2:

THK

MATL

FRP

FRP

FRP

FRP

FRP

FRP

BASE

EPOXY COVE

EPOXY COVE

EPOXY COVE

EPOXY COVE

EPOXY COVE

EPOXY COVE

ON 1412

ON 1411

G	P DOMESTIC COLD WATER DOMESTIC HOT WATER SUPPLY DOMESTIC HOT WATER RETURN GAS WASTE VENT PIPE ELBOW TURNS DOWN; UP PIPE TEES DOWN; UP PIPE CAP BALL VALVE CHECK VALVE CIRCUIT SETTER FLOOR CLEANOUT END-OF-LINE CLEANOUT CLEANOUT AT FINISH WALL (WCO)	AFC AFF AFG AFH AAV BFF CI CO CW DNT EWC (EX) FCO FD FDP FPHB GPH HB	ABOVE FINISH CEILING ABOVE FINISH FLOOR ABOVE FINISH GRADE ANTI-FREEZE HYDRANT AIR ADMITTANCE VALVE BELOW FINISHED FLOOR CAST IRON CLEANOUT COLD WATER DO NOT TAP ELECTRIC WATER COOLER EXISTING FLOOR CLEANOUT FLOOR DRAIN FLOOR DRAIN FLOOR DRAIN PARKING FREEZE-PROOF HOSE BIBB GALLONS PER HOUR HOSE BIBB CONNECT TO EXISTING POINT OF DEMOLITION	HD GCO HWS HWR IW LAV TYP UR V VTR W WC WCO WHA YCO	HUB DRAIN GRADE CLEANOUT HOT WATER SUPPLY HOT WATER RETURN INDIRECT WASTE LAVATORY TYPICAL URINAL VENT VENT THRU ROOF WASTE WATER CLOSET WALL CLEANOUT WATER HAMMER ARRESTOR YARD CLEANOUT
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- DRAINAGE PIPING SHALL BE RUN AT 1/8" PER FT SLOPE.
- 4. THE DESIGN/DETAIL/SCHEDULE SHOWN IS BASED ON (MANUFACTURER, MODEL) EQUIPMENT AND IS INTENDED ONLY TO SHOW THE GENERAL SIZE, CONFIGURATION, LOCATION, CONNECTIONS, AND/OR SUPPORT FOR EQUIPMENT OR SYSTEMS SPECIFIED WITH RELATION TO THE OTHER BUILDING SYSTEMS.
- INSTALL ALL PIPING AT THE MAXIMUM ELEVATION POSSIBLE. PROVIDE ALL FITTINGS, TRANSITIONS AND MATERIALS REQUIRED TO ACHIEVE MAXIMUM ELEVATION. COORDINATE ALL WORK WITH OTHER TRADES PRIOR TO THE START OF WORK TO AVOID CONFLICTS.
- 6. CONTRACTOR SHALL FURNISH ALL DISCONNECTS REQUIRED FOR PLUMBING EQUIPMENT.
- CONTRACTOR IS RESPONSIBLE FOR THE COORDINATION OF ALL MANUFACTURER SUBSTITUTIONS OF PLUMBING EQUIPMENT. SUBMIT A DESCRIPTION OF ANY/ALL CHANGES REQUIRED BY THE SUBSTITUTION, INCLUDING ELECTRICAL AND MECHANICAL CONNECTIONS, SIZES, WEIGHTS, AND CLEARANCES. THE CONTRACTOR SHALL BE RESPONSIBLE FOR ANY ADDITIONAL COST ASSOCIATED WITH THE
- 8. THE CONTRACTOR SHALL PERFORM ALL WORK IN ACCORDANCE WITH ALL FEDERAL, STATE, AND LOCAL CODES AND REGULATIONS. THE CONTRACTOR SHALL INFORM THE ARCHITECT AND/OR ENGINEER OF ANY CONFLICTS AS SOON AS THEY ARE DETECTED.
- CONTRACTORS MUST CAREFULLY COORDINATE THE ARRANGEMENT AND INSTALLATION OF THE DUCT, PIPING, AND CONDUIT IN THE MECHANICAL CHASES PRIOR TO THE START OF WORK. ALL PENETRATIONS SHALL BE SLEEVED AND FIRE-PROOFED.
- 10. ALL WORK SHALL BE NEW AND PROVIDED UNDER THIS CONTRACT UNLESS SPECIFICALLY MARKED "EX", "EXISTING", OR "EXIST.".
- 11. VERIFY LOCATIONS AND DIMENSIONS OF ALL EXISTING EQUIPMENT AND COORDINATE ALL WORK PRIOR TO THE START OF CONSTRUCTION.
- 12. THESE DRAWINGS ARE NECESSARILY DIAGRAMMATIC IN NATURE. NOT ALL FITTINGS, OFFSETS, VENTS, OR DRAINS ARE SHOWN. THE CONTRACTOR SHALL VISIT THE SITE PRIOR TO BIDDING AND INCLUDE ALL FITTINGS, OFFSETS, VENTS, AND DRAINS AS REQUIRED TO PROVIDE A COMPLETE AND FUNCTIONING

	FIXTURE PLUMBING SCHEDULE												
MARK	FIXTURE	FIXTURE				FAUCET							
WARK	FIXTURE	SPECIFICATION/DESCRIPTION	SAN	VENT	PICTURE	DESCRIPTION	COLD WATER	HOT WATER	FLOW RATE	PICTURE	REMARKS	ADA?	
<u>P-1</u>	WATER CLOSET	EXISTING WALL MOUNTED WATER CLOSET TO BE CLEANED AND RE-INSTALLED. PROVIDE NEW FLUSH VALVE, WALL SUPPORT, TRIM KIT, AND GASKET.	4"	2"	-	ZURN Z6000AV-WS1 OR EQUAL 1.6 GPF MANUAL FLUSH VALVE. PROVIDE WITH NON-HOLD OPEN HANDLE. REFER TO ARCHITECTURAL FOR ADA UNITS.	1"	-	1.6GPF		PROVIDE NEW ADJUSTABLE FIXTURE SUPPORT EQUAL TO JAY R. SMITH 0208Y SUPPORT LEGS & PLATE ONLY. COMPLETE WITH TRIM KIT & GASKET. NO-HUB HORIZONTAL WASTE & VENT FITTING TO REMAIN.		
<u>P-2</u>	URINAL	EXISTING WALL MOUNTED URINAL TO BE CLEANED AND RE-INSTALLED. PROVIDE NEW FLUSH VALVE, TRIM KIT, AND GASKET.	2"	1½"	-	ZURN Z6003AV-EWS OR EQUAL 0.5 GPF MANUAL FLUSH VALVE. PROVIDE WITH NON-HOLD OPEN HANDLE. REFER TO ARCHITECTURAL FOR ADA UNITS.	3/4"	-	0.5GPM		CLEAN, PAINT, AND RE-INSTALL EXISTING URINAL SUPPORT. PROVIDE NEW TRIM KIT AND GASKET.		
<u>P-3</u>	WALL MOUNTED LAVATORY	EXISTING WALL MOUNTED LAVATORY TO BE CLEANED AND RE-INSTALLED. PROVIDE FAUCET, TRAP, SUPPLIES, ADA INSULATION PACKAGE.	1½"	1½"	-	DELTA 591T1250 OR EQUAL BATTERY OPERATED FAUCET, CAST BRASS ONE-PIECE WITH WATERPROOF SENSOR, COMPLETE WITH SURFACE MOUNT BATTERY PACK	½"	½"	0.5GPM		PROVIDE WITH ¼ TURN BALL VALVES, AND CHROME-PLATED P-TRAP w/CLEANOUT. INSTALL TO COMPLY WITH ADA REQUIREMENTS. INSULATE P-TRAP FOR ADA COMPLIANCE. PROVIDE NEW CHROME STRAINER WITH TAILPIECE. CLEAN, PAINT, AND RE-INSTALL EXISTING LAVATORY SUPPORT.	Ğ	
<u>P-4</u>	SHOWER TRIM	EXISTING SHOWER DRAIN TO REMAIN. COVER AND PROTECT FOR DUST AND DEBRIS DURING ALL PHASES OF CONSTRUCTION.	-	-	-	DELTA T13H163 OR EQUAL SHOWER VALVE COMPLETE WITH MIXING VALVE, CHROME.	1/2"	½"	1.5GPM		PROVIDE COMPLETE WITH ROUGH-IN BOX.	-	
<u>P-5</u>	SHOWER TRIM	EXISTING SHOWER DRAIN TO REMAIN. COVER AND PROTECT FOR DUST AND DEBRIS DURING ALL PHASES OF CONSTRUCTION.	-	-	-	DELTA T13H153 OR EQUAL SHOWER VALVE & HEAD COMPLETE WITH MIXING VALVE, BRASS ELBOW, HOSE, HANDHELD SHOWER HEAD, 36" BAR, ADJUSTABLE SLIDE, CHROME.	½"	1/2"	1.5GPM		PROVIDE COMPLETE WITH ROUGH-IN BOX.	Ğ	
<u>P-6</u>	HOSE BIBB	INTERIOR DUTY, WITH VACUUM BREAKER	-	-		ZURN Z1341-PC OR EQUAL POLISHED CHROME	3⁄4"	-	-	-	MOUNT ON PIPE END.	-	
<u>P-7</u>	WALL HYDRANT WITH BOX	NARROW WALL HYDRANT	-	-		ZURN 1350 OR EQUAL, CHROME FINISH WITH VACUUM BREAKER	3/4"	-	-	-	PROVIDE HYD-RK-Z1350 KEY AND REPAIR KIT	-	
<u>P-8</u>	ELECTRIC WATER COOLER	ELKAY LZO8WSLK "EZH20" OR EQUAL SINGLE STATION WATER COOLER/BOTTLE FILLING STATION. STAINLESS STEEL CONSTRUCTION, VANDAL RESISTANT, WITH FILTER.	1½"	1½"		-	1⁄2"	-	8GPH	-	PROVIDE WITH SANITARY NO-TOUCH SENSOR ACTIVATION 8 GPH, MOUNT AT ADA HEIGHT. INSTALL BRACING AND SUPPORTS AS NECESSARY. BOTTLE FILLER SHALL DISPLAY BOTTLE SAVINGS. PROVIDE SPARE FILTER.	Ġ.	

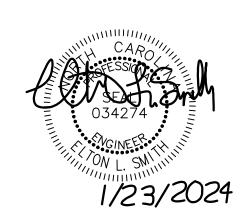
1. REFER TO MANUFACTURERS PREFERRED ALTERNATE OF DELTA FAUCETS AND SHOWER TRIM AS WELL AS ZURN FLUSH VALVES IN SPECIFICATIONS. 2. CLEAN AND PREP EXISTING FIXTURES TO BE RE-INSTALLED. MAKE ALL NEW CONNECTIONS OF WASTE, VENT, AND WATER CONNECTIONS TO EXISTING. 5 W Hargett Street 310 Raleigh, NC 27601 (919) 838-9337 osterlundarchitects.com

CONSULTANTS: SIGMA 5909 Falls of Neuse Rd Ste 101 Raleigh, NC 27609 License #: C-2490

PROJECT No.:

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SEALS:



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PLUMBING **COVER SHEET**

KEYED NOTES:

104D

102

CHANGING AREA

106D

ROOM

106

CHEM. DRY CHEM

A\$S STED

DRESSING

103

MECH. CHASE

- EXISTING WALL HUNG LAVATORY TO BE REMOVED, CLEANED, AND STORED IN A SAFE LOCATION FOR REINSTALLATION. REMOVE WALL CARRIER AND STORE IN A SAFE LOCATION FOR REINSTALLATION OF LAVATORY. REMOVE FAUCET, TRAP, STRAINER, AND STOPS. PROTECT WASTE, VENT, AND WATER PIPING DURING ALL PHASES OF CONSTRUCTION. PROVIDE TEMPORARY SUPPORT OF ALL WASTE, VENT, AND WATER PIPING. PREPARE PIPING FOR RECONNECTION OF FIXTURE. REMOVE ALL LOW VOLTAGE ELECTRONIC FAUCET WIRING. REFER TO FIXTURE SCHEDULE. PROVIDE NEW FAUCET, STOPS, SUPPLIES, TRAP, AND ADA PROTECTIVE COVERS.
- EXISTING WALL HUNG WATER CLOSET TO BE REMOVED, CLEANED. AND STORED IN A SAFE LOCATION FOR REINSTALLATION. REMOVE FLUSH VALVE AND CARRIER SUPPORT. WASTE AND VENT CONNECTION TO REMAIN. PROTECT WASTE, VENT, AND WATER PIPING AND PREPARE PIPING FOR RECONNECTION OF FIXTURE AND PROTECT DURING ALL PHASES OF CONSTRUCTION. PROVIDE TEMPORARY SUPPORT OF ALL WASTE, VENT AND WATER PIPING. PROVIDE NEW CARRIER SUPPORT AND FLUSH VALVE. REFER TO FIXTURE SCHEDULE.

CLASSROON

OFFICE

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1/8" = 1'-0"

INDOOR

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SWIMMING POOL

- EXISTING ELECTRIC WATER COOLER TO BE REMOVED. PROTECT WASTE, VENT, AND WATER PIPING. PREPARE PIPE FOR CONNECTION OF NEW FIXTURE AND PROTECT DURING ALL PHASES OF CONSTRUCTION. PROVIDE TEMPORARY SUPPORT OF WASTE, VENT, AND WATER PIPING. REFER TO FIXTURE SCHEDULE. PROVIDE NEW FIXTURE, TRAP, STOP, AND SUPPLIES.
- 4 SHOWER HEAD, AND TRIM TO BE REMOVED. PROTECT WASTE, VENT, AND WATER PIPING. PREPARE PIPE FOR CONNECTION OF NEW SHOWER HEAD. AND TRIM AND PROTECT DURING ALL PHASES OF CONSTRUCTION. PROVIDE TEMPORARY SUPPORT OF VENT AND WATER PIPING. REFER TO FIXTURE SCHEDULE.
- EXISTING HOSE BIBB TO BE REMOVED. PREP PIPE FOR INSTALLATION OF NEW HOSE BIBB AND PROTECT DURING ALL PHASES OF CONSTRUCTION. TEMPORARILY SUPPORT WATER PIPING. REFER TO FIXTURE SCHEDULE.

WOMEN'S

OCKER ROOM

104

TOILETS

104C

MECH. CHASE

PLUMBING WASTE AND VENT DEMOLITION FLOOR PLAN

/PÓØL/

EQUIPMENT/ WATER HEATERS

SINKS

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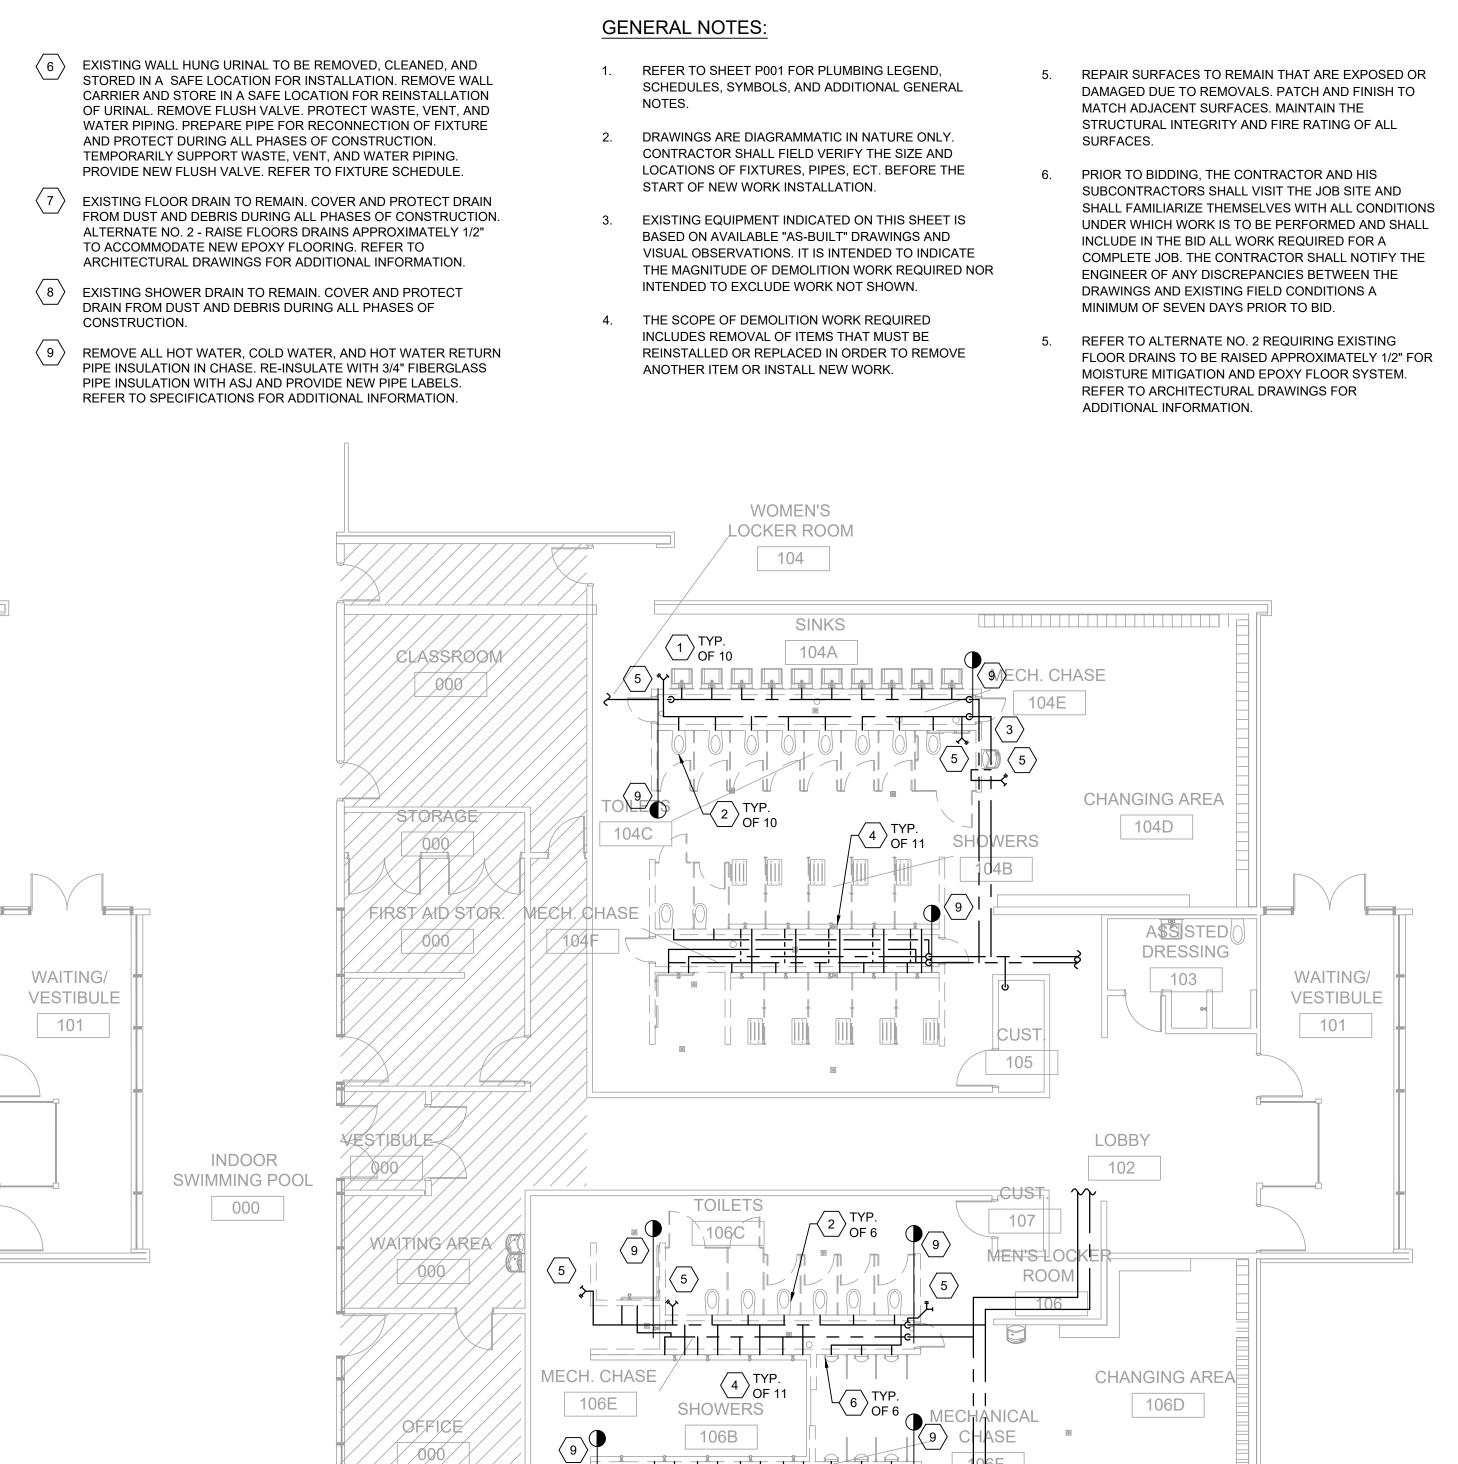
PROJECT No.:

SEALS:



ISSUE: CONSTRUCTION DATE: 01/26/2024 DRAWN BY: ELS **REVISIONS:**

> PLUMBING FLOOR PLAN -DEMOLITION



106A

/PÓØL/ EQUIPMENTI

WATER HEATERS

080

PLUMBING WATER DEMOLITION FLOOR PLAN

1/8" = 1'-0"

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TELECOM!

KEYED NOTES: NEW RECESSED SHALL WALL BOX MOUNTED HOSE BIBB. CONNECT EXISTING WALL HUNG LAVATORY TO BE REINSTALLED. CLEAN FIXTURE, PAINT AND INSTALL EXISTING SUPPORTS. PROVIDE TO EXISTING WATER.

BACKING AS NECESSARY. PROVIDE NEW FAUCET, TRAP, STOPS,

EXISTING WALL HUNG WATER CLOSET TO BE REINSTALLED.

PROVIDE NEW SUPPORT LEGS AND ANCHOR TO CONCRETE

FLOOR. PROVIDE ALL NEW SUPPORT BOLTS, TRIM KIT GASKET,

AND FLUSH VALVE . COORDINATE EXACT MOUNTING HEIGHT WITH

SUPPLIES, AND ADA PROTECTIVE JACKETS.

EXISTING WASTE AND WATER LOCATIONS.

- EXISTING FLOOR / SHOWER DRAIN TO REMAIN. ALTERNATE NO. 2 - RAISE FLOORS DRAINS APPROXIMATELY 1/2" TO ACCOMMODATE NEW EPOXY FLOORING. REFER TO ARCHITECTURAL DRAWINGS FOR ADDITIONAL INFORMATION.
- EXISTING WALL HUNG URINAL TO BE REINSTALLED CLEAN FIXTURE, PAINT AND INSTALL EXISTING SUPPORTS. PROVIDE BACKING AS NECESSARY. PROVIDE NEW SUPPORT BOLTS, GASKET, AND FLUSH VALVE. COORDINATE EXACT MOUNTING

GENERAL NOTES:

- 1. REFER TO SHEET P001 FOR PLUMBING LEGEND, SCHEDULES, SYMBOLS, AND ADDITIONAL GENERAL
 - DRAWINGS ARE DIAGRAMMATIC IN NATURE ONLY. CONTRACTOR SHALL FIELD VERIFY THE SIZE AND LOCATIONS OF FIXTURES, PIPES, ECT. BEFORE THE START OF NEW WORK INSTALLATION.
- REPAIR SURFACES TO REMAIN THAT ARE EXPOSED OR DAMAGED DUE TO REMOVALS. PATCH AND FINISH TO MATCH ADJACENT SURFACES. MAINTAIN THE STRUCTURAL INTEGRITY AND FIRE RATING OF ALL
- PRIOR TO BIDDING, THE CONTRACTOR AND HIS SUBCONTRACTORS SHALL VISIT THE JOB SITE AND SHALL FAMILIARIZE THEMSELVES WITH ALL CONDITIONS UNDER WHICH WORK IS TO BE PERFORMED AND SHALL INCLUDE IN THE BID ALL WORK REQUIRED FOR A COMPLETE JOB. THE CONTRACTOR SHALL NOTIFY THE ENGINEER OF ANY DISCREPANCIES BETWEEN THE DRAWINGS AND EXISTING FIELD CONDITIONS A MINIMUM OF SEVEN DAYS PRIOR TO BID.
- REFER TO ALTERNATE NO. 2 REQUIRING EXISTING MOISTURE MITIGATION AND EPOXY FLOOR SYSTEM. REFER TO ARCHITECTURAL DRAWINGS FOR

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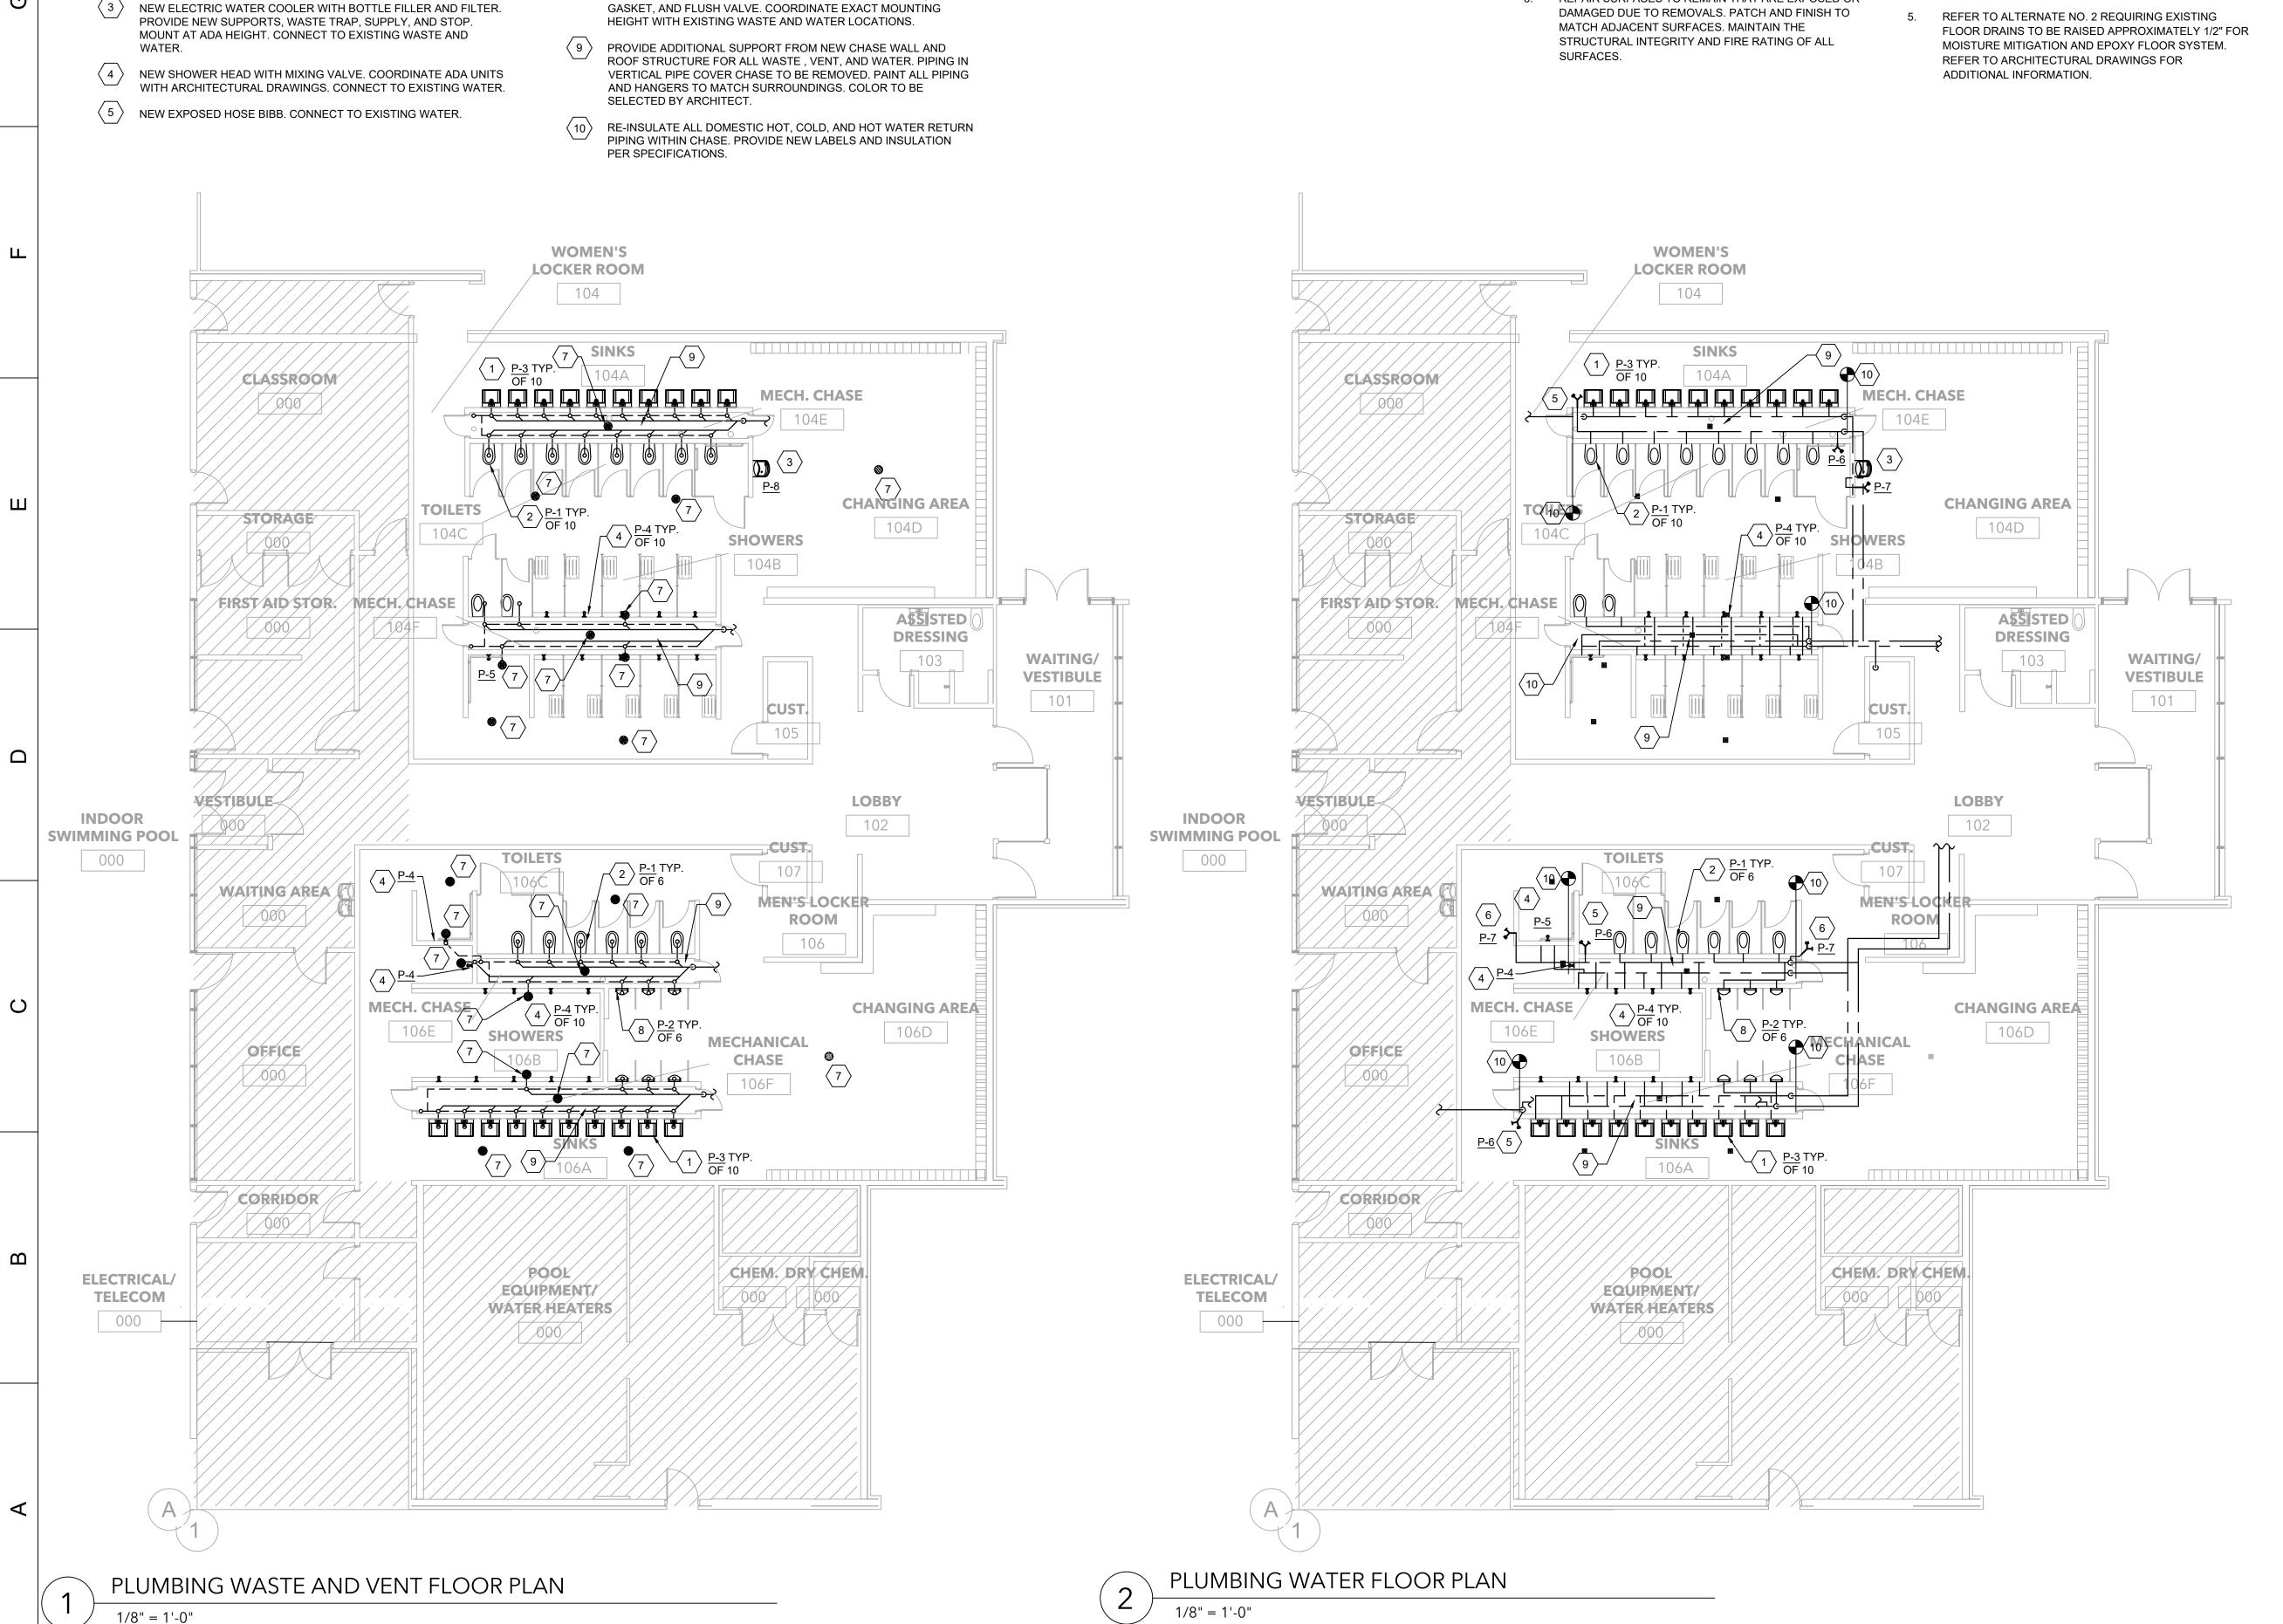
PROJECT No.:

SEALS:



ISSUE: CONSTRUCTION DATE: 01/26/2024 DRAWN BY: ELS **REVISIONS:**

PLUMBING FLOOR PLAN - NEW WORK



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METHOD OF COMPLIANCE: ENERGY CODE X PERFORMANCE PRESCRIPTIVE ASHRAE 90.1 PERFORMANCE PRESCRIPTIVE LIGHTING SCHEDULE LAMP TYPE REQUIRED IN FIXTURE NOT APPLICABLE NOT APPLICABLE NUMBER OF LAMPS IN FIXTURE NOT APPLICABLE BALLAST TYPE USED IN THE FIXTURE NOT APPLICABLE NUMBER OF BALLASTS IN FIXTURE NOT APPLICABLE TOTAL WATTAGE PER FIXTURE TOTAL INTERIOR WATTAGE SPECIFIED VS ALLOWED 400W VS 485W TOTAL EXTERIOR WATTAGE SPECIFIED VS ALLOWED NOT APPLICABLE ADDITIONAL EFFICIENCY PACKAGE OPTIONS (WHEN USING THE 2018 NCECC; NOT REQUIRED FOR ASHRAE 90.1) X C406.2 MORE EFFICIENT HVAC EQUIPMENT PERFORMANCE C406.3 REDUCED LIGHTING POWER DENSITY C406.4 ENHANCED DIGITAL LIGHTING CONTROLS C406.5 ON-SITE RENEWABLE ENERGY C406.6 DEDICATED OUTDOOR AIR SYSTEM C406.7 REDUCED ENERGY USE IN SERVICE WATER HEATING DESIGNER STATEMENT: TO THE BEST OF MY KNOWLEDGE AND BELIEF, THE DESIGN OF THIS BUILDING COMPLIES WITH THE ELECTRICAL SYSTEM AND EQUIPMENT, REQUIREMENT OF THE NORTH CAROLINA STATE BUILDING CODE SIGNED: REGGIE ADAMS P.E ELECTRICAL ENGINEER TITLE

ELECTRICAL SYSTEM AND EQUIPMENT

ELECTRICAL SYMBOLS

SD

1#10G 1"C —

WALL OR CEILING MTD EXIT SIGN WITH SELF CONTAINED BATTERY

WALL OR CEILING MTD EXIT SIGN WITH SELF CONTAINED BATTERY

WALL OR CEILING MTD EXIT/EMERGENCY COMBO UNIT WITH SELF

CONTAINED BATTERY BACK-UP, SINGLE OR DOUBLE FACE AS

DESIGNATED BY ARROW(S)WHEN USED INDICATES DIRECTION.

CEILING/PENDENT MTD/RECESSED LIGHTING FIXTURE AND

SUSPENDED OR SURFACE MTD LED LIGHTING FIXTURE

FIXTURE AND OUTLET, LETTER INDICATES FIXTURE TYPE

CEILING MTD OR LAY-IN TYPE LED LIGHTING FIXTURE

SUSPENDED OR SURFACE MTD LED LIGHTING FIXTURE

CIRCUIT ON UNSWITCHED NIGHT LIGHT CIRCUIT

AND OUTLET, LETTER DESIGNATES FIXTURE TYPE AND NUMBER

LETTER DESIGNATES FIXTURE TYPE AND NUMBER DESIGNATES

OUTLET BOX WITH BLANK COVER - LOCATE AS REQUIRED TO FOR

DESIGNATES CIRCUIT ON UNSWITCHED NIGHT LIGHT CIRCUIT

AND OUTLET, LETTER INDICATES FIXTURE TYPE

OUTLET, LETTER INDICATES FIXTURE TYPE,

CEILING MTD OR LAY-IN TYPE LED LIGHTING

WALL MOUNTED RECESSED LIGHTING FIXTURE AND OUTLET, LETTER INDICATES FIXTURE TYPE

NUMBER INDICATES CIRCUIT

NUMBER INDICATES CIRCUIT

NUMBER INDICATES CIRCUIT

NUMBER INDICATES CIRCUIT

TWO HEAD UNIT.

EQUIPMENT SERVED.

OUTLET, 20A, 125V, 3W

TELEVISION OUTLET.

RECEPTACLE.

NOTE TO ALL RECEPTACLES:

20A, 125V, 3W

EMERGENCY LIGHT BATTERY PACK -

DUPLEX RECEPTACLE AND OUTLET,

QUADRUPLEX RECEPTACLE AND

DUPLEX RECEPTACLE AND OUTLET 20A.

QUADRUPLEX RECEPTACLE AND OUTLET

FLUSH MOUNTED DUPLEX RECEPTACLE AND

COUNTER IF NO BACKSPLASH EXISTS.

125V, 3W, INSTALLED HORIZONTALLY 4" ABOVE

BACKSPLASH OR COUNTER IF NO BACKSPLASH EXISTS

20A, 125V, 3W, INSTALLED 4" ABOVE BACKSPLASH OR

1. SUBSCRIPT SP INDICATES SURGE SUPPRESSION PROTECTED

2. SUBSCRIPT WP INDICATES GROUND FAULT TYPE RECEPTACLE

4. SUBSCRIPT GFI INDICATES GROUND FAULT TYPE RECEPTACLE.

5. SUBSCRIPT TV INDICATES RECEPTACLE FOR TV MOUNTED IN

WITH STAINLESS STEEL WEATHERPROOF COVER.

3. SUBSCRIPT ISG INDICATES ISOLATED GROUND TYPE

6. SUBSCRIPT S INDICATES SURFACE MOUNTED DEVICE

7. SUBSCRIPT EM INDICATES EMERGENCY DEVICE

BACK-UP, DOUBLE FACE. ARROW WHEN USED INDICATES DIRECTION.

BACK-UP, SINGLE FACE. ARROW WHEN USED INDICATES DIRECTION.

FLUSH MTD TOGGLE SWITCH, S.P.S.T., 20A, 120/277V

FLUSH MTD 3-WAY TOGGLE SWITCH, 20A, 120/277V

FLUSH MTD 4-WAY TOGGLE SWITCH, 20A, 120/277V

CEILING MOUNTED DUAL-TECHNOLOGY OCCUPANCY SENSOR.

WALL MOUNTED OVER-RIDE SWITCH FOR MANUAL CONTROL OF

TELE/COMM OUTLET 4 11/16" SQ. BOX W/PULL STRINGS AND

CONCEALED RACEWAY. INDICATES 2#12 AND 1#12 GROUND

CONCEALED RACEWAY. ALL RACEWAYS WITH OTHER THAN

#12 CONDUCTORS WILL HAVE WIRE AND CONDUIT SIZES

ALL RACEWAYS SHALL CONTAIN A SEPARATE GREEN

1. SYMBOLS AND ABBREVIATIONS MAY NOT ALL BE UTILIZED FOR

2. SYMBOLS NOT LISTED IN THIS ELECTRICAL SYMBOL LEGEND ARE

3. MOUNTING HEIGHT GIVEN IN THE ELECTRICAL SPECIFICATIONS IS

TO THE CENTERLINE OF THE DEVICE AND SHALL BE FOLLOWED

IDENTIFIED ON THE DRAWINGS WHERE THEY OCCUR.

UNLESS OTHERWISE INDICATED AT THE SYMBOL, ON

ARCHITECTURAL ELEVATIONS OR CASEWORK DRAWINGS.

EQUIPMENT GROUND CONDUCTOR SIZED IN

ACCORDANCE WITH NEC 250.122.

ELECTRICAL SYMBOL NOTES

FLUSH MTD DIMMER SWITCH. SIZE AS NOTED

CEILING OCCUPANCY SENSOR.

1"C.TO PHONE/COMPUTER/ELECT. ROOM

PANEL BOARD, FLUSH MOUNTED

PANEL BOARD, SURFACE MOUNTED

IN 3/4" CONDUIT.

THIS PROJECT.

2018 APPENDIX B

BUILDING CODE SUMMARY FOR ALL COMMERCIAL PROJECTS

ELECTRICAL DESIGN

(PROVIDE ON THE ELECTRICAL SHEETS IF APPLICABLE)

ELECTRICAL SUMMARY

ABBREVIATIONS AMPERE, AMMETER ABOVE FINISHED FLOOR AMPERES INTERRUPTING CAPACITY AIR HANDLING UNIT AUTOMATIC TRANSFER SWITCH MANUAL MOTOR STARTER SWITCH WITHOUT OVERLOAD HEATERS BELOW FINISHED GRADE SWITCH TYPE OCCUPANCY SENSOR WITH BUILT-IN OVERRIDE SWITCH CONDUIT CATV CABLE (COMMUNITY) ANTENNA TELEVISION COPPER DISCONNECT ELECTRICAL CONTRACTOR TWO-COMPARTMENT RECESSED FLOOR BOX EQUAL TO LEGRAND RGB2 SERIES. PROVIDE WITH TWO DUPLEX RECEPTACLES AND FOUR DATA EGC EQUIPMENT GROUNDING CONDUCTOR PORTS. COORDINATE COVER STYLE AND COLOR WITH ARCHITECT. EWC ELECTRIC WATER COOLER ETR EXISTING TO REMAIN FA, F/A FIRE ALARM FIRE ALARM ANNUNCIATOR PANEL FIRE ALARM CONTROL PANEL FACP GROUNDING ELECTRODE CONDUCTOR GC GENERAL CONTRACTOR G,GND GROUND GF,GFI GROUND FAULT INTERRUPTER HANDHOLE HP HORSEPOWER ISOLATED GROUND JUNCTION BOX

LIGHTING LOW VOLTAGE

MECHANICAL CONTRACTOR MAIN CIRCUIT BREAKER MCC MOTOR CONTROL CENTER MANHOLE

> MAIN LUGS ONLY NON FUSED NOT IN CONTRACT

KILOVOLT-AMPERES

LIGHTING CONTACTOR

KILOWATTS

MAIN BREAKER

POLE, PHASE PLUMBING CONTRACTOR

NIGHT LIGHT

PANELBOARD

UNDERGROUND

TRANSFORMER

SOLID NEUTRAL SWITCH SWITCHBOARD

> UNLESS NOTED OTHERWISE UNO VOLT WEATHERPROOF

GENERAL NOTES

1. ALL WORK ON THIS PROJECT SHALL CONFORM TO THE 2020 NEC, ALL LOCAL AND STATE CODES, STATE BUILDING CODE AND REQUIREMENTS BY THE AUTHORITY HAVING

- 2. SYMBOLS AND ABBREVIATIONS MAY NOT ALL BE UTILIZED FOR THIS PROJECT.
- 3. UNLESS OTHERWISE INDICATED THE CONTRACTOR, IS RESPONSIBLE FOR ALL CUTTING, CORE- DRILLING AND PATCHING REQUIRED TO INSTALL ELECTRICAL RELATED
- 4. THE CONTRACTOR IS RESPONSIBLE FOR COORDINATING ELECTRICAL RELATED WORK WITH OTHER TRADES. THE CONTRACTOR IS CAUTIONED THAT IT IS TOTALLY HIS RESPONSIBILITY TO COORDINATE HANGERS AND SUPPORTS WITH OTHER TRADES. ADDITIONAL REQUIRED HANGERS & SUPPORTS MUST BE IN PLACE PRIOR TO APPLICATION OF FIRE PROOFING MATERIAL. ANY DAMAGE INCURRED ON FIRE PROOFING MATERIAL DUE TO INSTALLATION OF ELECTRICAL HANGERS WILL BE REPAIRED BY FIRE PROOFING SUB-CONTRACTOR AT NO ADDITIONAL COST TO THE OWNER.
- 5. UTILITIES SERVING AREAS OF THIS PROJECT STILL OCCUPIED BY THE OWNER DURING DEMOLITION AND NEW CONSTRUCTION SHALL BE MAINTAINED UNTIL THE OWNER VACATES THE AREA. UNLESS OTHERWISE NOTED.
- 6. ALL SHUTDOWNS WILL BE COORDINATED AND APPROVED THROUGH THE OWNER'S PROJECT MANAGER AND THE BUILDING MANAGER AND WILL REQUIRE ADVANCE NOTICE OF 10 WORKING DAYS EXCLUDING WEEKEND. THIS TIME LENGTH MAY BE LONGER OR SHORTER FOR SOME SHUTDOWNS AT THE OWNER'S DISCRETION. THE SCHEDULING OF SUCH SHUTDOWNS MAY TAKE TWO WEEKS OR MORE AND THE CONTRACTOR MUST BE PREPARED TO WORK SECOND OR THIRD SHIFT, SATURDAY OR SUNDAY AS NECESSARY TO PERFORM THE WORK. FURTHERMORE, IN SOME CASES AN ALTERNATE POWER SOURCE MAY BE REQUIRED, THE CONTRACTOR MUST BE PREPARED TO MAKE TAPS, INSTALL CIRCUIT BREAKERS, ETC., WHILE EXISTING EQUIPMENT IS ENERGIZED. ALL SHUTDOWNS WILL BE INITIATED AND CONTROLLED BY OWNER.
- VISIT THE SITE PRIOR TO BID DATE AND EXAMINE ALL AREAS TO BE DEMOLISHED AND RENOVATED. THOROUGHLY FAMILIARIZE YOURSELF WITH EXISTING CONDITIONS. NO EXTRA COMPENSATION WILL BE GIVEN FOR FAILURE TO THOROUGHLY EXAMINE EXISTING CONDITIONS TO DETERMINE THE EXACT SCOPE OF DEMOLITION WORK. "KEYED" NOTES ON THE DEMOLITION DRAWINGS ARE PROVIDED TO ASSIST BIDDERS TO DETERMINE THE SCOPE OF DEMOLITION WORK.
- 8. EXISTING AREAS WHETHER WITHIN OR WITHOUT THE "GENERAL LIMITS OF CONSTRUCTION", SHALL BE REPAIRED WHERE ANY DAMAGE HAS OCCURRED DUE TO CONSTRUCTION BY THE CONTRACTOR.
- 9. ALL AREAS OUTSIDE THE PROJECT LIMITS IN WHICH WORK MUST TAKE PLACE WILL BE CLEANED AND RETURNED TO NORMAL (INCLUSIVE OF CEILING TILE REPLACEMENT) AT THE END OF EACH DAY. THE CONTRACTOR SHALL COORDINATE WITH THE OWNER'S REPRESENTATIVE EACH DAY BEFORE LEAVING THE CONTRACT PROJECT LIMITS REGARDING THE CLEANLINESS OF THE AREA IN WHICH WORK TOOK PLACE OUT SIDE OF THE PROJECT LIMITS.
- 10. WHERE WORK IS TAKING PLACE OUTSIDE THE PROJECT LIMITS CANNOT ALLOW A RETURN TO NORMAL APPEARANCE OF WALLS, CEILING, ETC., AT THE END OF EACH DAY DUE TO ITS EXTENSIVE NATURE; THE CONTRACTOR SHALL ERECT A BLACK PLASTIC CURTAIN AROUND HIS WORK. SUCH A CURTAIN SHALL REMAIN IN PLACE UNTIL THE WORK IS COMPLETE. SUCH CURTAINS WILL HAVE CAUTIONARY SIGNS AFFIXED INDICATING CONSTRUCTION ACTIVITY WITHIN.
- 11. USE 3/4" DEEP MUD RINGS ON BOXES IN 5/8" DRYWALL SO FACE OF RING IS FLUSH WITH FACE OF DRYWALL. PROVIDE CADDY #RLC ADAPTER ON ALL OUTLETS WHERE DRYWALL IS CUT IN EXCESS OF 1/8" LARGER THAN MUD RING OR WHERE THE DEVICE "EARS" ARE NOT SUPPORTED BY THE DRYWALL
- 12. 20A BRANCH CIRCUIT WIRE SIZING SHALL BE IN ACCORD WITH THE FOLLOWING TABLE

REMAININE

		INCINCINDEIN	
VOLTS	DISTANCE	(FIRST DEVICE)	OF CIRCUIT
120/208	0' - 50'	#12	#12
	50' - 100'	#10	#12
	100' - 150'	# 8	#10

- 13. THE ELECTRICAL CONTRACTOR SHALL VERIFY LOCATION OF LIGHTS, ETC. IN MECHANICAL ROOMS WITH MECHANICAL CONTRACTOR BEFORE ROUGH-IN TO AVOID CONFLICT WITH DUCT WORK AND PLUMBING ROUTING.
- 14. ALL BRANCH CIRCUIT BREAKERS SHALL BE 20A, 1P, WITH 2 #12 AWG 1#12 GND IN 3/4" MINIMUM CONDUIT, UNLESS OTHERWISE NOTED.
- 15. ALL WIRING LUGS THROUGHOUT THE PROJECT, INCLUDING BUT NOT LIMITED TO BREAKERS, PANELBOARD/SWITCHBOARD LUGS, SAFETY SWITCH LUGS, AND TRANSFORMER LUGS, SHALL BE RATED FOR USE WITH 75 DEGREE CONDUCTORS SIZED IN ACCORDANCE WITH NEC TABLE 310-15 (B) (16).
- 16. ALL RACEWAYS SHALL BE METAL UNLESS SPECIFICALLY NOTED OR APPROVED OTHERWISE.
- 17. CONTRACTOR SHALL MINIMIZE NUMBER OF HOME RUN CONDUITS. CONTRACTOR MAY COMBINE UP TO THREE CIRCUITS PER HOME RUN IN A SINGLE CONDUIT.
- 18. IN GENERAL ALL ELECTRICAL CONDUIT WILL BE RUN AT THE ELEVATION JUST BELOW THE BOTTOM OF THE STRUCTURAL BEAMS. THE CONTRACTOR SHALL OFFSET THE ELECTRICAL CONDUIT TO AVOID INTERFERENCE WITH ANY DUCTWORK, SPRINKLER OR MECHANICAL PIPING. THE CONTRACTOR SHALL COORDINATE HIS CONDUIT AND RACEWAY LOCATIONS WITH ALL OTHER TRADES BEFORE INSTALLATION.
- 19. THE ROUTING FOR THE RACEWAY SHOWN ON THE DWGS. IS DIAGRAMMATIC ONLY, BASED ON CURSORY FIELD SURVEY BY DESIGNER. CONTRACTOR IS CAUTIONED THAT SPACE ABOVE CLG. IS VERY CONGESTED WITH EXISTING MECHANICAL, ELECTRICAL & PLUMBING ITEMS, AND WORK SPACE IS LIMITED. CONTRACTOR IS REQUIRED TO VISIT THE SITE PRIOR TO BID DATE AND LOOK ABOVE THE CLG. OF THE PROPOSED ROUTING TO FAMILIARIZE HIMSELF WITH EXISTING CONDITIONS. PROVIDE ANY AND ALL ADDITIONAL JB'S, OFFSETS, CONDUITS AND FITTINGS AS REQUIRED TO AVOID ANY EXIST. OBSTRUCTIONS ALONG THE PROPOSED ROUTING. ANY SHUTDOWNS CAUSED BY RELOCATING EXISTING EQUIPMENT SHALL BE COORDINATED WITH OWNER. FAILURE TO EXAMINE EXISTING CONDITIONS AND COORDINATE THE EXACT CONDUIT ROUTING WILL NOT EXCUSE CONTRACTOR FROM PERFORMING ALL DUTIES NECESSARY TO COMPLETE THE WORK. DO NOT ROUTE CONDUIT IN A MANNER THAT WILL BLOCK ACCESS TO EXISTING ITEMS AS JUNCTION BOXES, VALVES, FILTERS OR SERVICE ACCESS TO EQUIPMENT.
- 20. WIRE AND CIRCUIT BREAKERS ARE SIZED FOR SPECIFIC EQUIPMENT. BEFORE ORDERING WIRE, BREAKERS AND CONDUIT FOR THIS PROJECT, THE ELECTRICAL CONTRACTOR SHALL COORDINATE WITH THE OTHER CONTRACTORS ON THE JOB AND SHALL VERIFY THE ELECTRICAL DATA FOR EQUIPMENT WHICH WILL ACTUALLY BE INSTALLED BY THE OTHER CONTRACTORS AND RECOMPUTE WIRE AND BREAKER SIZES IF REQUIRED TO COMPLY WITH THE N.E.C.
- 21. LABEL ALL CONDUITS TERMINATING IN THE CEILING CAVITIES.
- 22. ALL CONDUIT (WITH OR WITHOUT WIRES) SHALL BE COLOR CODED WITH 1/2" WIDE TAPE, 10'-0" ON CENTER, IN ACCORDANCE WITH THE FOLLOWING:

120/208 VOLT COMMUNICATION/SOUND FIRE ALARM TELEPHONE	BLACK GREEN RED LIGHT BLUI
TELEPHONE	LIGHT BLUE

- 23. THE MOUNTING HEIGHTS AND LOCATIONS OF ALL WALL MOUNTED OUTLETS, JUNCTION BOXES AND DISCONNECT SWITCHES SHALL BE REVIEWED AND COORDINATED WITH CASEWORK DRAWINGS AND ACTUAL EQUIPMENT LOCATION, PRIOR TO INSTALLATION. ANY DIFFERENCES SHALL BE THE RESPONSIBILITY OF THE ELECTRICAL CONTRACTOR.
- 24. THE ELECTRICAL CONTRACTOR SHALL VERIFY ALL CEILING TYPES AND FINISHES BEFORE PURCHASE OF ANY LIGHT FIXTURES SO THAT THE PROPER TRIM WILL BE PROVIDED FOR THE CEILING TO BE INSTALLED. ANY DIFFERENCES SHALL BE THE RESPONSIBILITY OF THE ELECTRICAL CONTRACTOR.
- 25. EACH CONTRACTOR SHALL PROVIDE HIS OWN SUPPORT OF ALL DEVICES AND EQUIPMENT PROVIDED BY HIM AND SHALL SUPPORT SUCH EQUIPMENT PER APPROVED GOVERNING CODES OR PER APPROVAL OF THE ENGINEER. UNACCEPTABLE WORKMANSHIP OR MATERIALS SHALL BE REPLACED AT THE REQUEST OF THE ENGINEER AT THE CONTRACTOR'S EXPENSE.
- 26. THE CONTRACTOR SHALL REFER TO THE ARCHITECTURAL PLANS FOR FLOOR PLAN DIMENSIONS. DO NOT SCALE THESE DRAWINGS.
- 27. THE ELECTRICAL CONTRACTOR SHALL COORDINATE ANY AND ALL WORK WITH OTHER TRADES INVOLVED IN THE PROJECT, PRIOR TO THE INSTALLATION OF HIS EQUIPMENT, SO AS TO AVOID CONFLICTS DURING CONSTRUCTION AND TO ALLOW FOR OPTIMUM MAINTENANCE AND WORKING SPACE. PROVIDE COORDINATION DRAWINGS TO THE ENGINEER FOR APPROVAL. ANY REWORK THAT NEEDS TO BE DONE DO TO CONFLICTS BETWEEN TRADES SHALL BE DONE AT THIS CONTRACTORS EXPENSE.
- 28. ALL LIGHT FIXTURES SHALL BE SUPPORTED INDEPENDENTLY OF THE SUSPENDED CEILING SYSTEM. REFER TO THE SPECIFICATIONS FOR MORE DETAILED INFORMATION.
- 29. WHERE ELECTRICAL EQUIPMENT PENETRATES EXTERIOR WALLS OR THE ROOF, THEY SHALL BE PROPERLY SEALED WITH METHODS APPROVED BY THE ENGINEER. SUBMIT DETAIL OF PROPOSED WORK.
- 30. IN ALL AREAS WHERE THE FIRE RATED WALLS, FLOORS AND CEILINGS ARE INSTALLED OR ARE EXISTING, ALL PENETRATIONS OF ELECTRICAL CONDUITS OR OTHER RELATED ELECTRICAL MATERIALS SHALL BE PROPERLY SEALED WITH APPROVED FIRE RATED MATERIALS TO MAINTAIN THE RATINGS OF THE BUILDING CONSTRUCTION.
- 31. ALL FUSES, DISCONNECT SWITCHES AND BREAKER SIZES, SHOWN FOR MECHANICAL EQUIPMENT, SHALL BE VERIFIED BEFORE THE PURCHASE OR INSTALLATION OF SAID EQUIPMENT, WITH THE EQUIPMENT SUPPLIER AND MECHANICAL CONTRACTOR.
- 32. UPON COMPLETION OF WORK ALL KEYS TO ELECTRICAL POWER PANELS SHALL BE TURNED OVER TO THE OWNER AND A SIGNED RECEIPT SHALL BE OBTAINED.
- 33. ALL MULTIWIRE BRANCH CIRCUITS NEED TO HAVE SEPARATE NEUTRAL CONDUCTORS TO COMPLY WITH NEC 2020 ARTICLE 210.4. NO SHARED NEUTRAL CONDUCTORS PERMITTED ON THIS PROJECT.
- 34. ANY RECEPTACLE WITH-IN 6'-0" OF A SINK SHALL BE A GROUND FAULT TYPE (GFI) RECEPTACLE.
- 35. ALL WORK ON THIS PROJECT SHALL BE INSTALLED IN COMPLIANCE WITH ANSI A117.1, ADA STANDARDS FOR ACCESSIBLE AND USABLE BUILDINGS AND FACILITIES.

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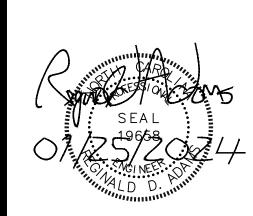
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PROJECT No.

License #: C-2490

2325

SEALS:



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ELECTRICAL LEGEND, SYMBOLS, NOTES

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WOMEN'S LOCKER ROOM 104 SINKS 104A CLASSROOM MECH. CHASE \000/ CHANGING AREA SHOWERS STØRAGE 104D Ш FIRST AID STOR ASSISTED C 000/ DRESSING 103 WAITING/ **VESTIBULE** 101 MEN'S LOCKER LOBBY ROOM 102 106 INDOOR **3WIMMING POOL** 000 107 MAITING AREA 000 CHANGING AREA **MECHANICAL** CHASE 106D 106B \circ OFFICE 000 SINKS ETR 106A 000 /ETR/ ELECTRICALI/ TELECOM 000 /POOK/ CHEM. DRY CHEM ÉQUIPMENT! $\mathbf{\Omega}$ WATER HEATERS 000/

LIGHTING DEMOLITION FLOOR PLAN

1/8" = 1'-0"

GENERAL NOTES:

- REFER TO SHEET E001 FOR SYMBOLS, ABBREVIATIONS, AND OTHER NOTES PERTAINING TO CONSTRUCTION.
- 2. REMOVE ALL RECEPTACLES, LIGHT FIXTURES, AND ASSOCIATED SWITCHING SHOWN ON PLANS; UNLESS NOTED OTHERWISE. REMOVE EXISTING CONDUIT AND REMOVE WIRING BACK NEAREST REMAINING JUNCTION BOX AT CEILING LEVEL. LABEL EACH CIRCUIT FOR RECONNECTION TO NEW DEVICES IN NEW CHASE WALLS. REMOVE ALL BOXES FROM DEMOLISHED WALLS.
- 3. ALL CIRCUITS IN WOMEN'S AND MEN'S LOCKER ROOMS ARE FED FROM PANEL "BB1". REFER TO PANELBOARD SCHEDULE ON SHEET E400 FOR CIRCUIT DESIGNATION AND PANELBOARD INFORMATION.
- 4. EXISTING EMERGENCY/EGRESS LIGHTING IS SHOWN ON PLAN AS REFERENCE AND ARE DENOTED WITH "ETR". THESE FIXTURES SHALL REMAIN IN PLACE AND OPERATIONAL.

1/8" = 1'-0"

KEYED NOTES:

- REMOVE EXISTING HAND DRYER OUTLET AND REMOVE CIRCUIT BACK TO NEAREST JUNCTION BOX AT CEILING LEVEL. LABEL CIRCUIT AND KEEP IN PLACE FOR CONNECTION TO NEW HAND DRYERS.
- REMOVE EXISTING WATER COOLER RECEPTACLE. REMOVE EXISTING CIRCUIT BACK TO NEAREST JUNCTION BOX AT CEILING LEVEL. LABEL CIRCUIT AND KEEP IN PLACE FOR CONNECTION TO NEW HAND DRYERS.

WOMEN'S

LOCKER ROOM

3 LOCATION OF EXISTING PANEL "BB1" SHOWN FOR REFERENCE ONLY. PANEL SHALL REMAIN IN PLACE AND OPERATIONAL.

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PROJECT No.: 2325

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OPTIMIST POOL BATHHC
REPAIRS
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CITY OF RALEIGH

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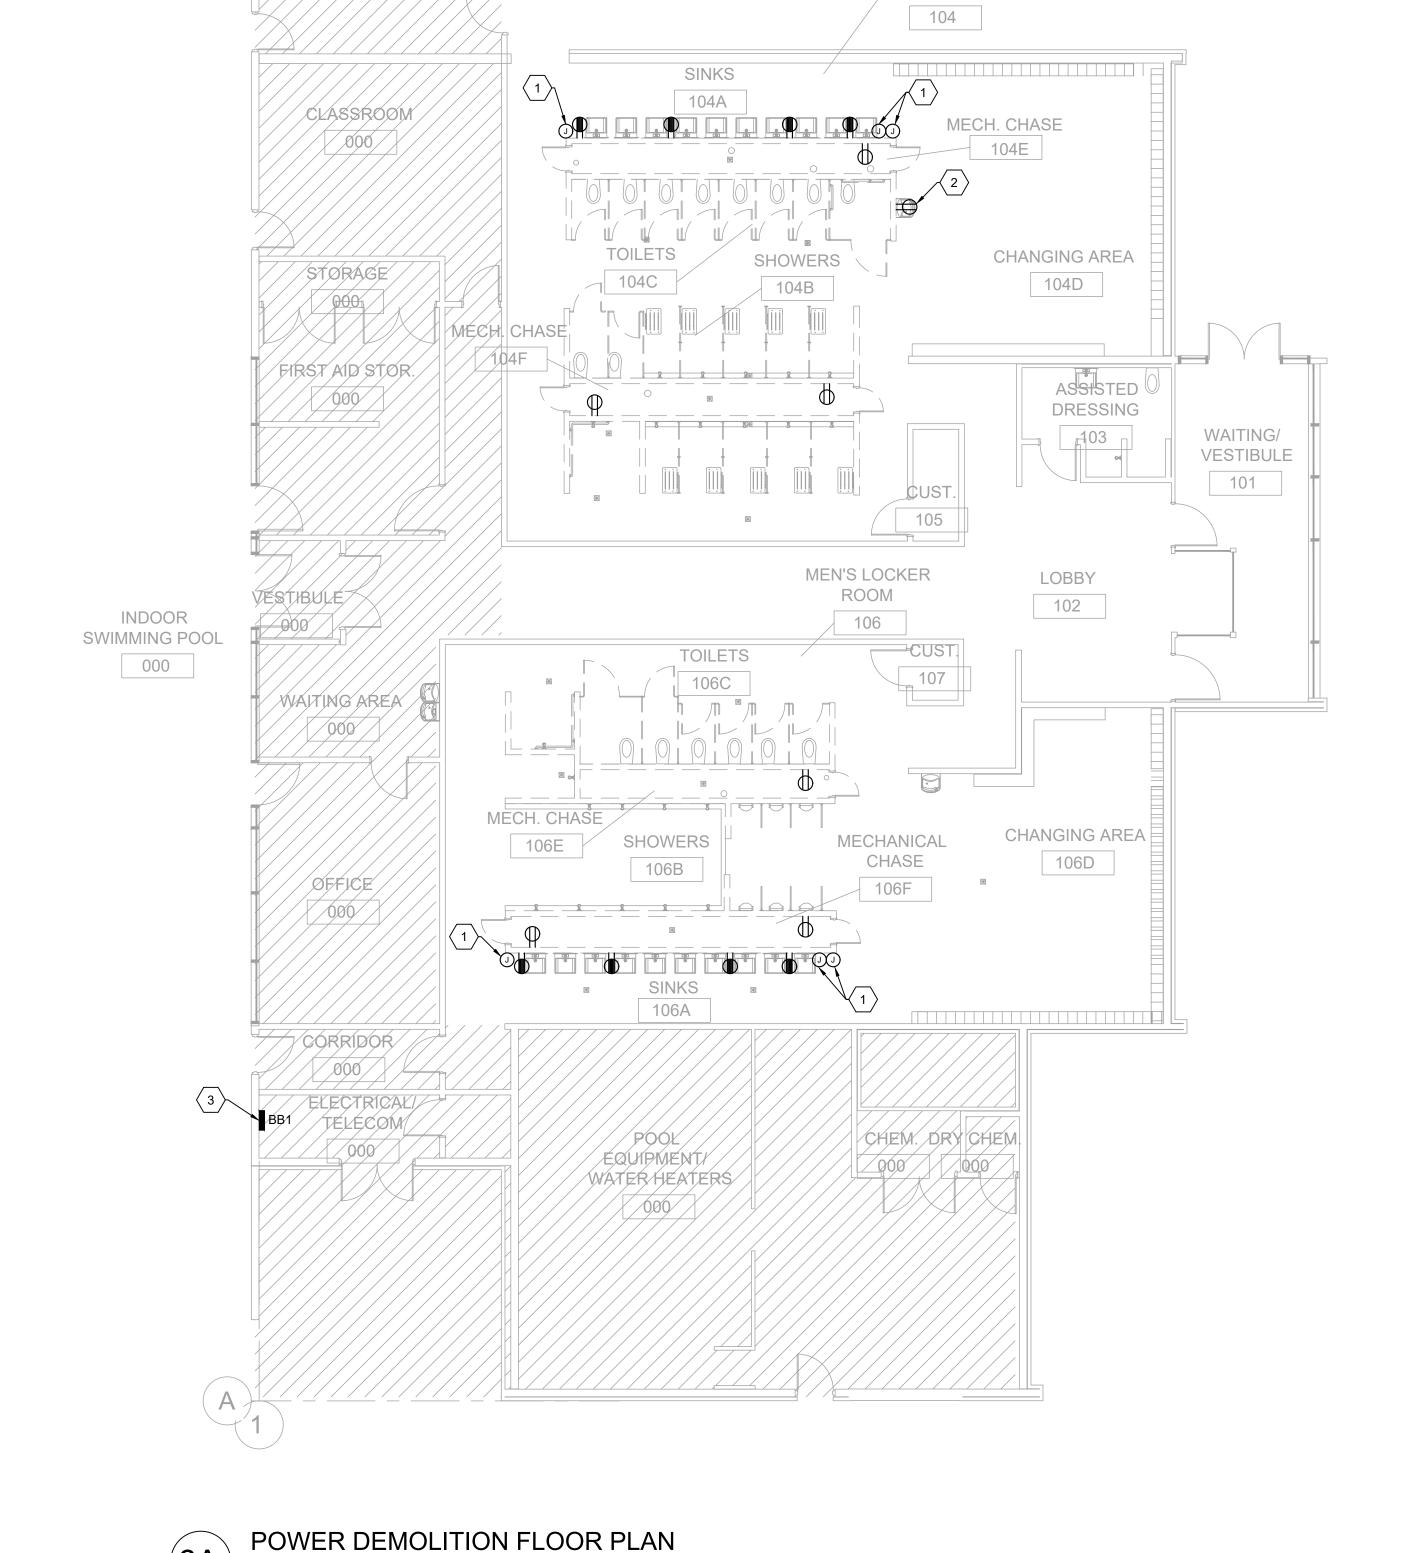


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> ELECTRICAL DEMOLITION FLOOR PLAN

> > E100

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INDOOR

SWIMMING POOL

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GENERAL NOTES: 1. REFER TO SHEET E001 FOR SYMBOLS, ABBREVIATIONS, AND OTHER NOTES PERTAINING TO CONSTRUCTION. 2. ALL NEW DEVICES SHALL BE RECESSED IN NEW FINISHED WALLS WALLS.

- 3. ALL CIRCUITS IN WOMEN'S AND MEN'S LOCKER ROOMS ARE FED FROM PANEL "BB1". REFER TO PANELBOARD SCHEDULE ON SHEET E400 FOR CIRCUIT DESIGNATION AND PANELBOARD INFORMATION.
- 4. EXISTING EMERGENCY/EGRESS LIGHTING IS SHOWN ON PLAN AS REFERENCE. ALL EMERGENCY FIXTURES SHALL REMAIN IN PLACE AND OPERATIONAL.
- 5. NEW EMERGENCY LIGHTS SHALL BE WIRED AHEAD OF ANY SWITCHES.

WOMEN'S

LOCKER ROOM

104

CHANGING AREA

104D

LOBBY

102

CHANGING AREA

106D

ASSISTED

DRESSING

WAITING/

VESTIBULE

101

MECH. CHASE

SINKS ETR

SHOWERS

MEN'S LOCKER

ROOM

106

MECHANICAL

CHASE

106F

CHEM. DRY CHEM

ETR

106E

106B

106A

/POOK/

ÆQUIPMENT/

WATER HEATERS

ETR

CLASSROOM

/000/

FIRST AID STOR

/000/

000

OFFICE

000/

000

/ELECTRICAL/ TELECOM

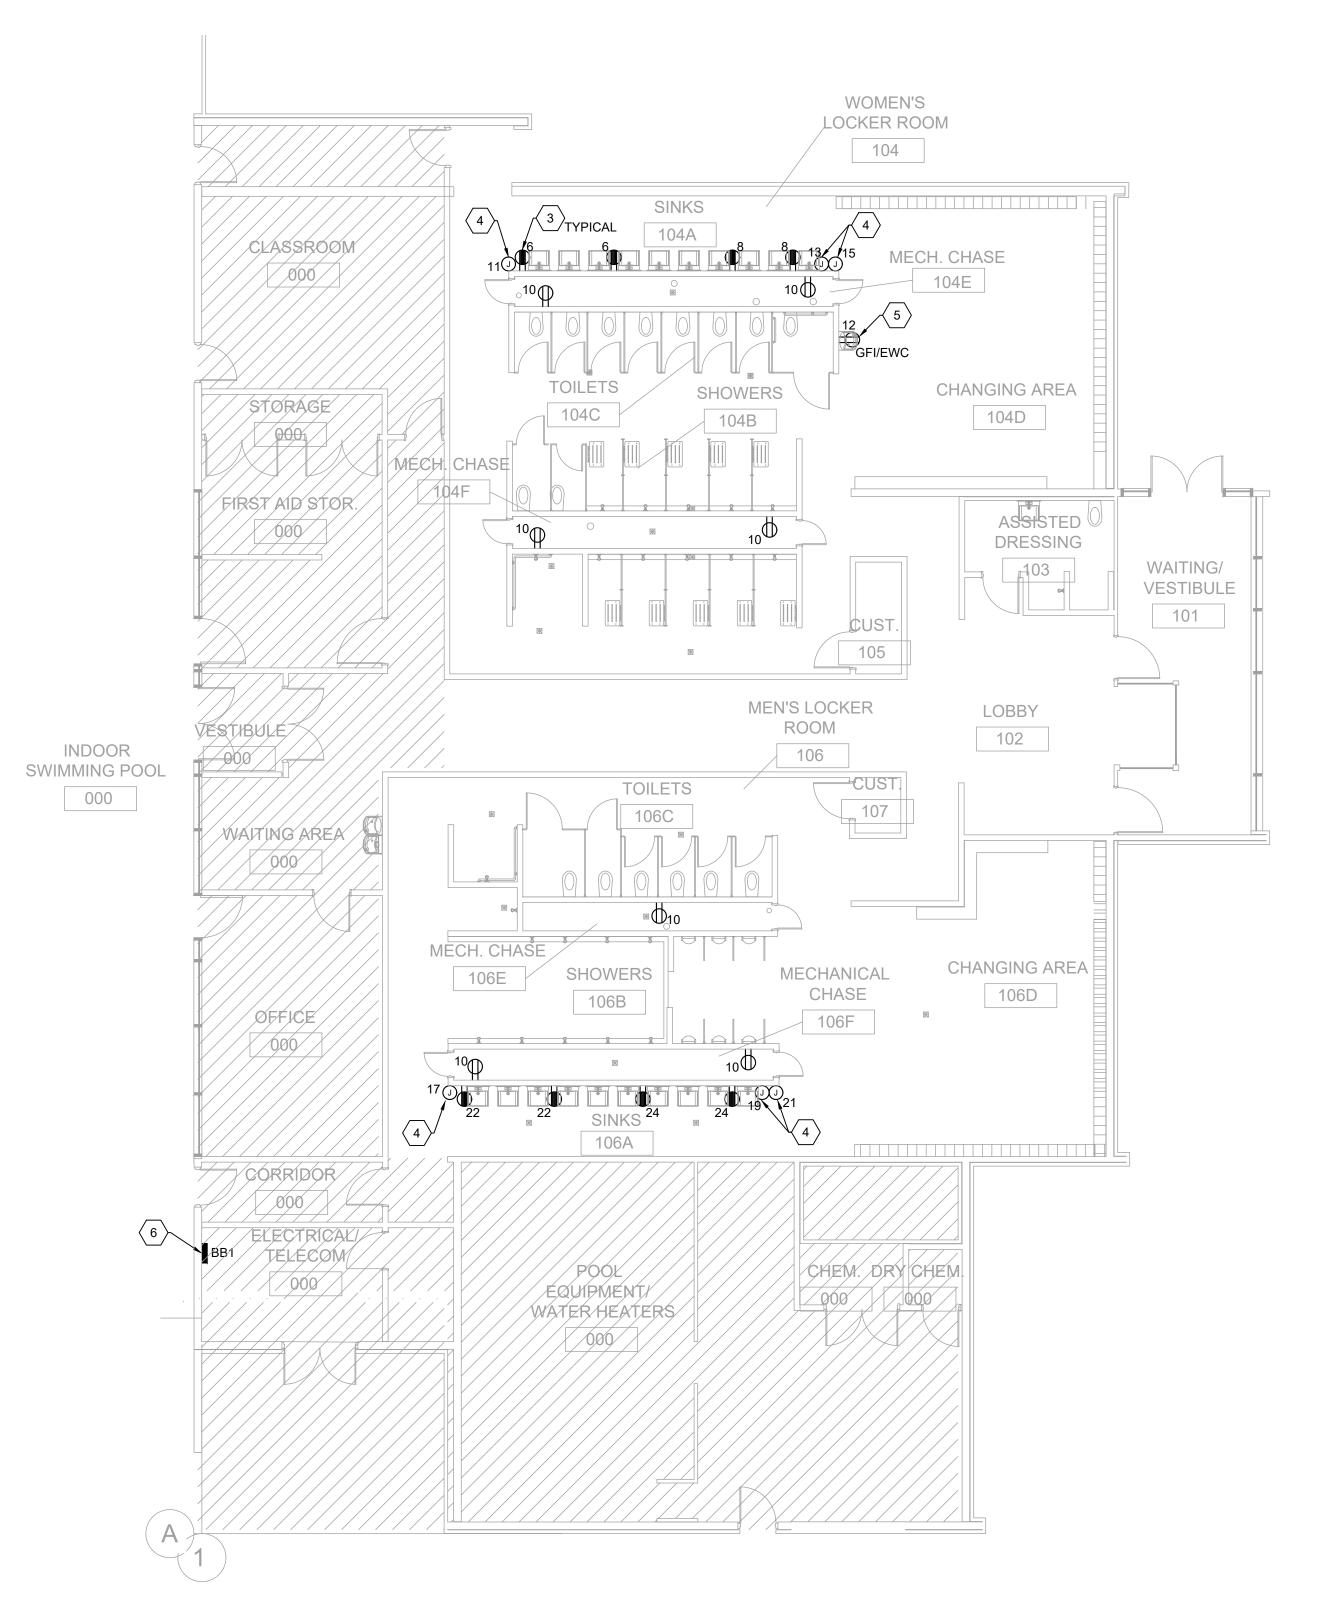
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LIGHTING NEW WORK FLOOR PLAN

1/8" = 1'-0"

KEYED NOTES:

- \langle 1 \rangle PROVIDE NEW WALL MOUNTED LINEAR LED FIXTURE MOUNTED ABOVE MIRROR. EXTEND EXISTING LIGHTING CIRCUIT RETAINED FROM DEMOLITION PHASE AND CONNECT TO NEW FIXTURES.
- PROVIDE NEW WALL MOUNTED LINEAR LED FIXTURE MOUNTED INSIDE CHASE. MOUNT FIXTURE 12" BELOW TOP OF CHASE OR AS HIGH AS POSSIBLE TO AVOID CONFLICTS WITH PLUMBING PIPES.
- (3) PROVIDE NEW GFCI, DUPLEX RECEPTACLE. EXTEND EXISTING RECEPTACLE CIRCUIT RETAINED FROM DEMOLITION PHASE AND CONNECT TO NEW DEVICE. NUMBER NEXT TO DEVICE DENOTES CIRCUIT FROM PANEL "BB1".
- FROM DEMOLITION PHASE. COORDINATE MOUNTING HEIGHTS AND EXACT LOCATION WITH ARCHITECT PRIOR TO ROUGH-IN.
- 6 LOCATION OF EXISTING PANEL "BB1" SHOWN FOR REFERENCE ONLY. PANEL SHALL REMAIN IN PLACE AND OPERATIONAL



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ELECTRICAL NEW WORK FLOOR PLAN

POWER NEW WORK FLOOR PLAN

1/8" = 1'-0"

FIXTURES SHALL BE CONTROLLED WITH EXISTING ROOM SWITCHING UNLESS NOTED OTHERWISE.

PROVIDE NEW SWITCHES AT EACH CHASE ENTRANCE TO CONTROL FIXTURES INSIDE CHASE ONLY.

PROVIDE NEW RECESSED WALL OUTLET AND EXTEND EXISTING HAND DRYER CIRCUIT RETAINED

 \langle 5 \rangle PROVIDE NEW GFCI, DUPLEX RECEPTACLE FOR ELECTRIC WATER COOLER. ENSURE THAT DEVICE IS LOCATED TO ALLOW READILY AVAILABLE ACCESS TO GFCI RESET WITHOUT DISASSEMBLY OR MODIFICATIONS TO WATER COOLER.

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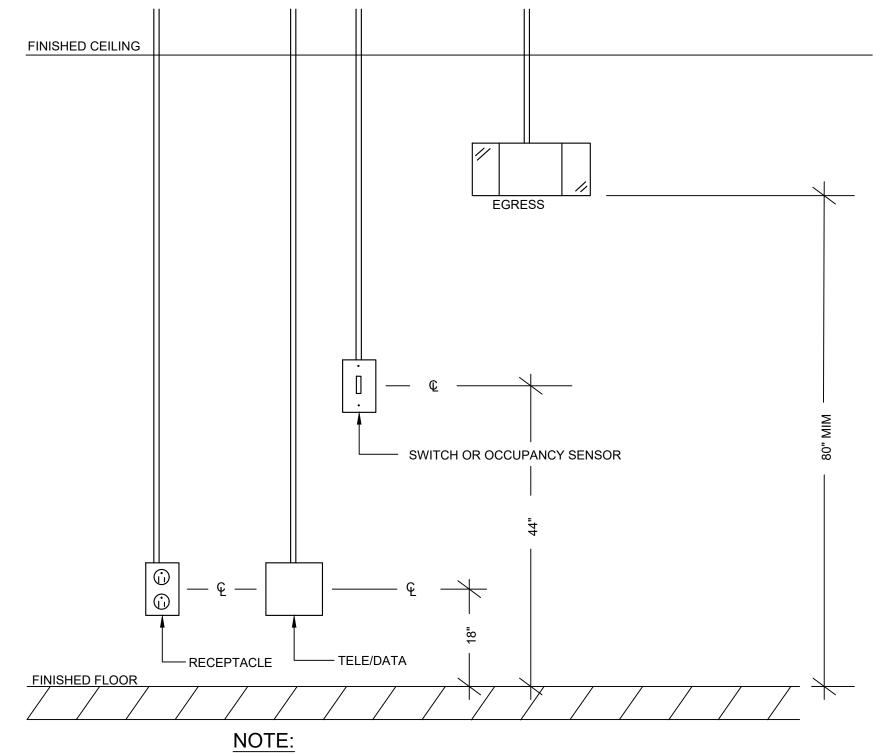
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5 W Hargett Street 310 Raleigh, NC 27601 (919) 838-9337 osterlundarchitects.com CONSULTANTS: SIGMA 5909 Falls of Neuse Rd Ste 101 Raleigh, NC 27609 License #: C-2490 2325 PROJECT No.: SEALS: ISSUE: CONSTRUCTION DATE: 01/26/2024 DRAWN BY: SDR **REVISIONS: ELECTRICAL DETAIS**

PROVIDE CLEAR SELF-ADHESIVE LABEL. PROVIDE CLEAR SELF-ADHESIVE - PROVIDE CLEAR SELF-ADHESIVE LETTERING TO BE 3/8" IN HEIGHT. COLOR LABEL. LETTERING TO BE 3/8" IN LABEL. LETTERING TO BE 3/8" IN OF LABELING TO BE FIELD VERIFIED. LABEL HEIGHT. COLOR OF LABELING TO HEIGHT. COLOR OF LABELING TO BE FIELD VERIFIED. LABEL TO READ SCHEME TO BE VERIFIED WITH OWNER'S BE FIELD VERIFIED. LABEL TO REPRESENTATIVE. TYPICAL ALL WALL DELINEATE PANEL FEEDING DEVICE READ DELINEATE PANEL FEEDING DEVICE AND ITS CIRCUIT NUMBER.
TYPICAL ALL OCCUPANCY AND ITS CIRCUIT NUMBER. TYPICAL MOUNTED TELECOM. OUTLETS ALL RECEPTACLES. SENSORS AND SWITCHES. PANEL-XX PANEL-XX SWITCH OR OCCUPANCY SENSOR-WALL MOUNTED RECEPTACLE DATA OUTLET

DEVICE LABELING DETAILS



NOT ALL DEVICES MAY BE USED IN CONSTRUCTION.

NFPA 72 AND ADA MOUNTING HEIGHT DETAILS

NO SCALE

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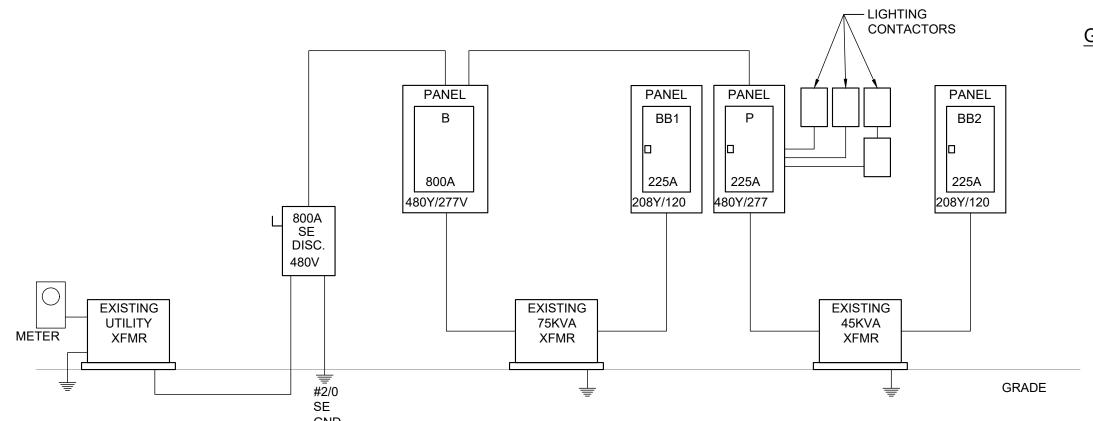
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POWER RISER DIAGRAM

GENERAL NOTES:

 ALL EQUIPMENT SHOWN IS EXISTING TO REMAIN UNLESS NOTED OTHERWISE.

	EXISTING				PANEL	TYPE:	SQ D N1		MCB o	r MLO:			1000 AMP MCB	
	PANEL "BB1"				BUS SI	ZE:	225		MOUN	TING:			SURFACE	
	FED FROM UTILITY XFMR				VOLTA	GE:	208Y/120V		MINIM	JM AIC:			10,000	
СКТ	LOAD SERVED	TRIP	POLE	WIRE	kVA	k'	VA PER PHA		kVA	WIRE	POLE	TRIP	LOAD SERVED	CK
						Α	В	С						
1	EM LIGHTS/LTS, RMS 06,07,09	20	1		0.33	0.33					1	20	REC, RM 07 CLASSROOM	2
3	EM LIGHTS, LTS RMS 04, WOMEN'S	20	1		0.33		0.33				1	20	REC, RM 09 FIRST AID/GUARD RM	4
5	EM LIGHTS/LTS, RMS 01,02,10	20	1					0.36	0.36		1	20	REC, RM 04 WOMEN'S LOCKER RM	6
7	EM LIGHTS/LTS, RM 17	20	1			0.36			0.36		1	20	REC, RM 04 WOMEN'S LOCKER RM	8
9	EM & EXT LTS/RELAY IN POOL AREA	20	1				1.26		1.26		1	20	REC, MECHANICAL CHASE	10
11	HAND DRYER-WOMEN'S	20	1		1.00			1.80	0.80		1	20	EW COOLER	12
13	HAND DRYER-WOMEN'S	20	1		1.00	1.00					1	20	REC, RMS 01,03,05-FAMILY DRESSING RM	14
15	HAND DRYER-WOMEN'S	20	1		1.00		1.00				1	20	REC, RM 02 LOBBY	16
17	HAND DRYER-MEN'S	20	1		1.00			1.00					SPACE	18
19	HAND DRYER-MEN'S	20	1		1.00	1.00					1	20	REC, RM 12 OFFICE	20
21	HAND DRYER-MEN'S	20	1		1.00		1.36		0.36		1	20	REC, RM 06 MEN'S LOCKER RM	22
23	SPACE							0.36	0.36		1	20	REC, RM 06 MEN'S LOCKER RM	24
25	UH-1	20	1			0.00					1	20	TELEPHONE BOARD	26
27	UH-2	20	1				0.00				1	20	CATV BOARD	28
29		400	_					0.00			1	20	LIGHTS & REC - SPRINLER	30
31		100	2			0.00					1	20	UH-2	32
33	UH-3	20	1				0.00				1	20	UH-1	34
35	311.4							0.00			_		UP.4	36
37	AH-1	60	2			0.00					- 2	60	HP-1	38
39							0.00					0.5	UDO	40
41	AH-2	50	2					0.00			2	25	HP-2	42
				•	TOTALS:	2.69	3.95	3.52						12
											т			
		DESCF	RIPTION	١		CONTRACTOR OF THE PARTY OF THE	TED LOAD	DF		ID LOAD				
							(VA)		,	VA)				
		DEMOLIS					0.80	125%		3.50				
			RECEP1	S			.70	100%		70	1			
		LIGHTS					.65	125%		81				
		HVAC LA	REST M	OTOR			.00	125%		.00	1			
		REMAINI	NGHVA				.00	100%		.00]			
		ELEVATO	OR				.00	100%		.00	1			
		MISC.					.80	80%		44	1			
		TOTAL (F	(VA)			-0).65		-4	.55	Ī			
		TOTAL A	MPS			-1	1.80		-12	2.62]			

NOTES:

NO LOAD ADDED TO EXISTING PANEL

* DENOTES REVISED LOAD ON EXISTING BREAKER.

	LIGHTING FIXTURE SCHEDULE											
TYPE	DESCRIPTION	MANUF. NAME	MANUFACTURER CAT. NUMBERS	LAMPS	INPUT WATTS	VOLTS	MOUNTING	REMARKS				
		COLUMBIALIGHTING	CSL4-A-LSCS	3500K LED	32.5							
Α	LINEAR LED STRIP LIGHT	LITHONIA	APPROVED EQUAL	4400 LUMENS		120	WALL					
		SIGNIFY	APPROVED EQUAL									
	COMPACT EMERGENCY LIGHT WITH DUAL	COLUMBIALIGHTING	CU2									
	ADJUSTABLE, ROUND LAMPS. DAMP LOCATION	LITHONIA	APPROVED EQUAL	3500k LED	1	120	WALL					
	LISTED.	SIGNIFY	APPROVED EQUAL									
NOTES	IOTES:											
MODEL	NUMBERS SHOWN ARE BASIS OF DESIGN. EQUAL	MANUFACTURER'S SHAL	L BE SUBMITTED PER NC GS 133.									

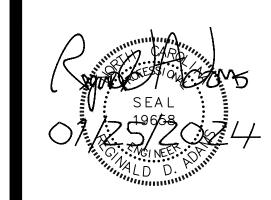
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POWER RISER AND SCHEDULES

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