

301 Glenwood Ave, Suite 270, Raleigh, NC 27603 984.222.0572

# **ADDENDUM NO. 1**

# **NCSU** Renovations to the Don Ellis Building

SCO ID# 19-21547 NCSU ID# 201920037 SFK PROJECT NO. 1368-20

# SKINNER FARLOW KIRWAN ARCHITECTURE RALEIGH, NORTH CAROLINA

December 5, 2023

#### **NOTICE TO CONTRACTORS:**

The Contract Documents for the above-referenced Project are modified as set forth in this Addendum. The original Contract Documents and any previously issued addenda remain in full force and effect, except as modified by this Addendum, which is hereby made part of the Contract Documents. Bidder shall take this Addendum into consideration when preparing and submitting a bid.

All principal contractors shall be responsible for seeing that their subcontractors are properly apprised of the contents of this Addendum. All contractors shall acknowledge receipt of the Addendum.

#### **GENERAL**

#### Bid Submittal Deadline - unchanged

#### **SPECIFICATIONS**

- 1. Bid Form: Replace Bid Form with the attached for corrections to preferred brand alternates.
- 2. Section 012300 "Alternates": Part 3, paragraph 3.1, sub-paragraph H. <u>add</u>, <u>Von Duprin</u> to the list of preferred brands in the alternate. And sub- item 2 <u>add Von Duprin panic</u> <u>hardware</u> to the paragraph descirption

3. Section 142400 "Oil Hydraulic Elevators": Part 2, paragraph 2.3.B item 13. **Replace** "does not exceed 15 horsepower" with "does not exceed 20 horsepower"

#### **DRAWINGS**

- 1. Sheet D-100: **Replace** with sheet D-100 attached
  - a. Additional notes are added to the sheet
- 2. Sheet A-100: *Replace* with sheet A-100 attached
  - a. The door location for the data closet is changed.
- 3. Sheet A-101: *Replace* with sheet A-101 attached
  - a. The door location for the data closet is changed.
- 4. Sheet A-102: *Replace* with sheet A-102 attached
  - a. The data closet is changed.
- 5. Sheet A-110: *Replace* with sheet A-110 attached
  - a. The door location for the data closet is changed.
- 6. Sheet A-111: Replace with sheet A-111 attached
  - a. The door location for the data closet is changed.
- 7. Sheet A-200: *Replace* with sheet A-200 attached
  - a. Side elevation at mechanical electrical room provided
- 8. Sheet A-700 : *Replace* with sheet A-700 attached
  - a. Accent walls indicated
- 9. Sheet L-100; *Replace* with sheet L-100 attached.
  - a. Notes revised under property data
- 10. Sheet L-200: *Replace* with sheet L-200 attached.
  - a. Bike racks added to plans with notes
- 11. Sheet L-300: **Replace** with sheet L-300 attached
  - a. Area of disturbance adjusted
- 12. Sheet L-400: *Replace* with sheet L-400 attached
  - a. Planting bed adjusted
- 13. PD-201: Clarification: Refer to general note #1 for scope of work for the demolition and capping of all existing floor drains and floor openings related to the existing plumbing. All floors shall also be patched as noted. This is in reference to all existing floor drains and floor openings that are no longer in use.

# 14. P-202: Revise: Keyed note #6 shall be revised to read <u>"THE PLUMBING"</u> <u>CONTRACTOR SHALL CONNECT AND ROUTE THE NEW 4" SANITARY PIPE</u> <u>TO THE EXISTING MANHOLE."</u>

### Clarifications

No.	Question / Issue	Response
1	Please verify what is proposed to be done if lead based paint is on the walls	The contractor is to be familiar with all information included in the hazardous materials reports regarding items indicated in the full set of construction documents whether to be removed, surfaces to be prepared for new paint or paint to be removed and intact paint to be encapsulated with new paint.
2	Would a dual single stage holeless jack system be acceptable for this project?	No, this was vetted during design. NCSU requires a holed hydraulic elevator for low rise buildings as a campus standard.
3	Overhead power	The overhead power from the transformer will need to be replaced. These changes will be included in a future addendum.
4	Paint Schedule	An updated paint schedule with accent colors and field colors will be provided in a future addendum

#### **END OF ADDENDUM NO. 1**

### FORM OF PROPOSAL

Don Ellis Building Renovation	Contract: General Construction
North Carolina State University	Bidder:
SCO ID: # 19-21547-02A / NCSU ID: # 201920037	
principals is or are named herein and that no other person the contract to be entered into; that this proposal is made without bid or proposal; and that it is in all respects fair and in good for he has examined the site of the work and the contract docume prior to the opening of bids; that he has satisfied himself rel	person or persons interested in this proposal as principal or nan herein mentioned has any interest in this proposal or in the connection with any other person, company or parties making a faith without collusion or fraud. The bidder further declares that ents relative thereto, and has read all special provisions furnished ative to the work to be performed. The bidder further declares CGS 64, Article 2 in regards to E-Verification as required by Stat. § 143-129(j).
The Bidder proposes and agrees if this proposal is	accepted to contract with the
North Carolina	State University
in the form of contract specified below, to furnish a apparatus, means of transportation and labor nece	all necessary materials, equipment, machinery, tools, ssary to complete the construction of
<u>Don Ellis Buil</u>	ding Renovation
in full in complete accordance with the plans, sp entire satisfaction of the State of North Carolina, ar	ecifications and contract documents, to the full and
North Carolina State University, and	d Skinner Farlow Kirwan Architecture.
with a definite understanding that no money will General Conditions and the contract documents, for SINGLE PRIME CONTRACT:	be allowed for extra work except as set forth in the or the sum of:
Base Bid:	D-II(f)
	Dollars(\$)
General Subcontractor:	Plumbing Subcontractor:
Lic	Lic
Mechanical Subcontractor:	Electrical Subcontractor:
Lic	Lic
accepted shall not substitute any person as subcontractor in the pla subcontractor's bid is later determined by the contractor to be non-re	ontractors for the above subdivisions of work. A contractor whose bid is ace of the subcontractor listed in the original bid, except (i) if the listed esponsible or non-responsive or the listed subcontractor refuses to enter with the approval of the awarding authority for good cause shown by the
ALTERNATES: Should any of the alternates as described in the contract	ct documents be accepted, the amount written below shall

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be the amount to be "added to" or "deducted from" the base bid. (Strike out "Add" or "Deduct" as appropriate.)

### **GENERAL CONTRACT:**

Alternate No. 1	Full Build-out of 2 <sup>nd</sup> floor Ceilings and Associated Lighting and HVAC 2 <sup>nd</sup> Floor
(Add) (Deduct)	Dollars(\$)
Alternate No. 2	Carpet 2 <sup>nd</sup> Floor
(Add) (Deduct)	Dollars(\$)
Alternate No. 3	Additional Walls and Doors on 2 <sup>nd</sup> Floor
(Add) (Deduct)	Dollars(\$)
Alternate No. 4	New Entry Vestibule & Additional Exterior Flatwork per Drawings
(Add) (Deduct)	Dollars(\$)
Alternate No. 5	Loading Dock Canopy
(Add) (Deduct)	Dollars(\$)
Alternate No. 6	Free Standing Pre-fabricated Aluminum Canopy
(Add) (Deduct)	Dollars(\$)
Alternate No. 7	2 <sup>nd</sup> Boiler
(Add) (Deduct)	Dollars(\$)
Alternate No. 8	Door Hardware by LCN, Von Duprin and Best (Preferred Brands)
(Add) (Deduct)	Dollars(\$)
Alternate No. 9	Fire Alarm Dialers by Firelite (Preferred Brand)
(Add) (Deduct)	Dollars(\$)
Alternate No. 10	Elevator Controls by MRE and Phone by Gaintronics (Preferred Brand)
(Add) (Deduct)	Dollars(\$)
Alternate No. 11	Sanitary Napkin Disposal Unit by Bobrick (Preferred Brand)
(Add) (Deduct)	Dollars(\$)

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Unit prices quoted and accepted shall apply throughout the life of the contract, except as otherwise specifically noted. Unit prices shall be applied, as appropriate, to compute the total value of changes in the base bid quantity of the work all in accordance with the contract documents.

#### **GENERAL CONTRACT:**

No. 1 Removal of Unsatisfac. Soil	Unit <u>Cu. Yd</u>	Unit Price (\$)	
No. 2 Brick Repair and Repointing	. Unit Per Brick	Unit Price (\$)	

#### MINORITY BUSINESS PARTICIPATION REQUIREMENTS

<u>Provide with the bid</u> - Under GS 143-128.2(c) the undersigned bidder shall identify <u>on its bid</u> (Identification of Minority Business Participation Form) the minority businesses that it will use on the project with the total dollar value of the bids that will be performed by the minority businesses. <u>Also</u> list the good faith efforts (Affidavit A) made to solicit minority participation in the bid effort.

**NOTE**: A contractor that performs all of the work with its <u>own workforce</u> may submit an Affidavit (**B**) to that effect in lieu of Affidavit (**A**) required above. The MB Participation Form must still be submitted even if there is zero participation.

<u>After the bid opening</u> - The Owner will consider all bids and alternates and determine the lowest responsible, responsive bidder. Upon notification of being the apparent low bidder, the bidder shall then file within 72 hours of the notification of being the apparent lowest bidder, the following:

**Note**: Bidders must always submit <u>with their bid</u> the Identification of Minority Business Participation Form listing all MB contractors, <u>vendors and suppliers</u> that will be used. If there is no MB participation, then enter none or zero on the form. Affidavit A **or** Affidavit B, as applicable, also must be submitted with the bid. Failure to file a required affidavit or documentation with the bid or after being notified apparent low bidder is grounds for rejection of the bid.

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### **Proposal Signature Page**

The undersigned further agrees that in the case of failure on his part to execute the said contract and the bonds within ten (10) consecutive calendar days after being given written notice of the award of contract, the certified check, cash or bid bond accompanying this bid shall be paid into the funds of the owner's account set aside for the project, as liquidated damages for such failure; otherwise the certified check, cash or bid bond accompanying this proposal shall be returned to the undersigned.

Respectfully submitte	d this day of			
(Name of firm or corporation making bid)				
WITNESS:		Ву:		
		Signature		
		· · · · · · · · · · · · · · · · · · ·		
(Proprietorship or P	Partnership)	Print or type		
		(Owner/Partner/Pres	s./V.Pres)	
		Address		
ATTECT.				
ATTEST:				
Ву <u>:</u>		License No		
Title:		Federal I.D. No.		
(Corp. Sec. or As				
		Email Address:		
(00000047)	5 0541)			
(CORPORATI	E SEAL)			
Addendum received a	and used in computing bid:			
		_ Addendum No. 5 Addendum No. 6	Addendum No. 7 Addendum No. 8	

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project status

Construction

I 12/05/2023 Rev.

12 DEMO TO DIMENSION SHOWN - VERIFY IN FIELD THAT END OF WALL WILL BE A MINIMUM OF 12"

BEYOND BEARING OF STAIR BEAM ON WALL. 13 DEMO EXISTING 4" PIPING - REPLACE WITH NEW PIPING TO EXISTING MANHOLE, SEE PME SHEETS

14 REMOVE EXISTING HANDRAILS, CAREFULLY STORE FOR REUSE.

PROJECT **1368-20** DATE 11/20/2023 DRAWN **ADQ** 


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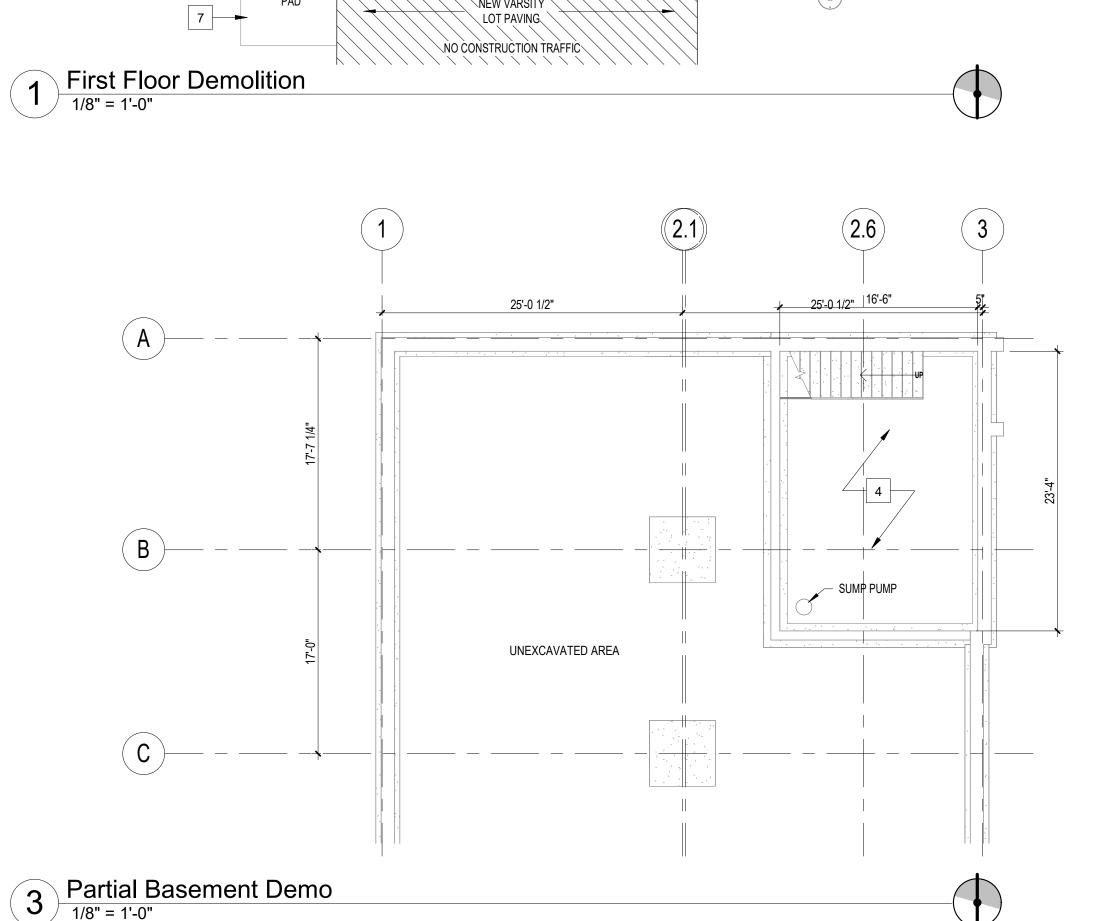
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Building

**Demo Plans** 

sheet name



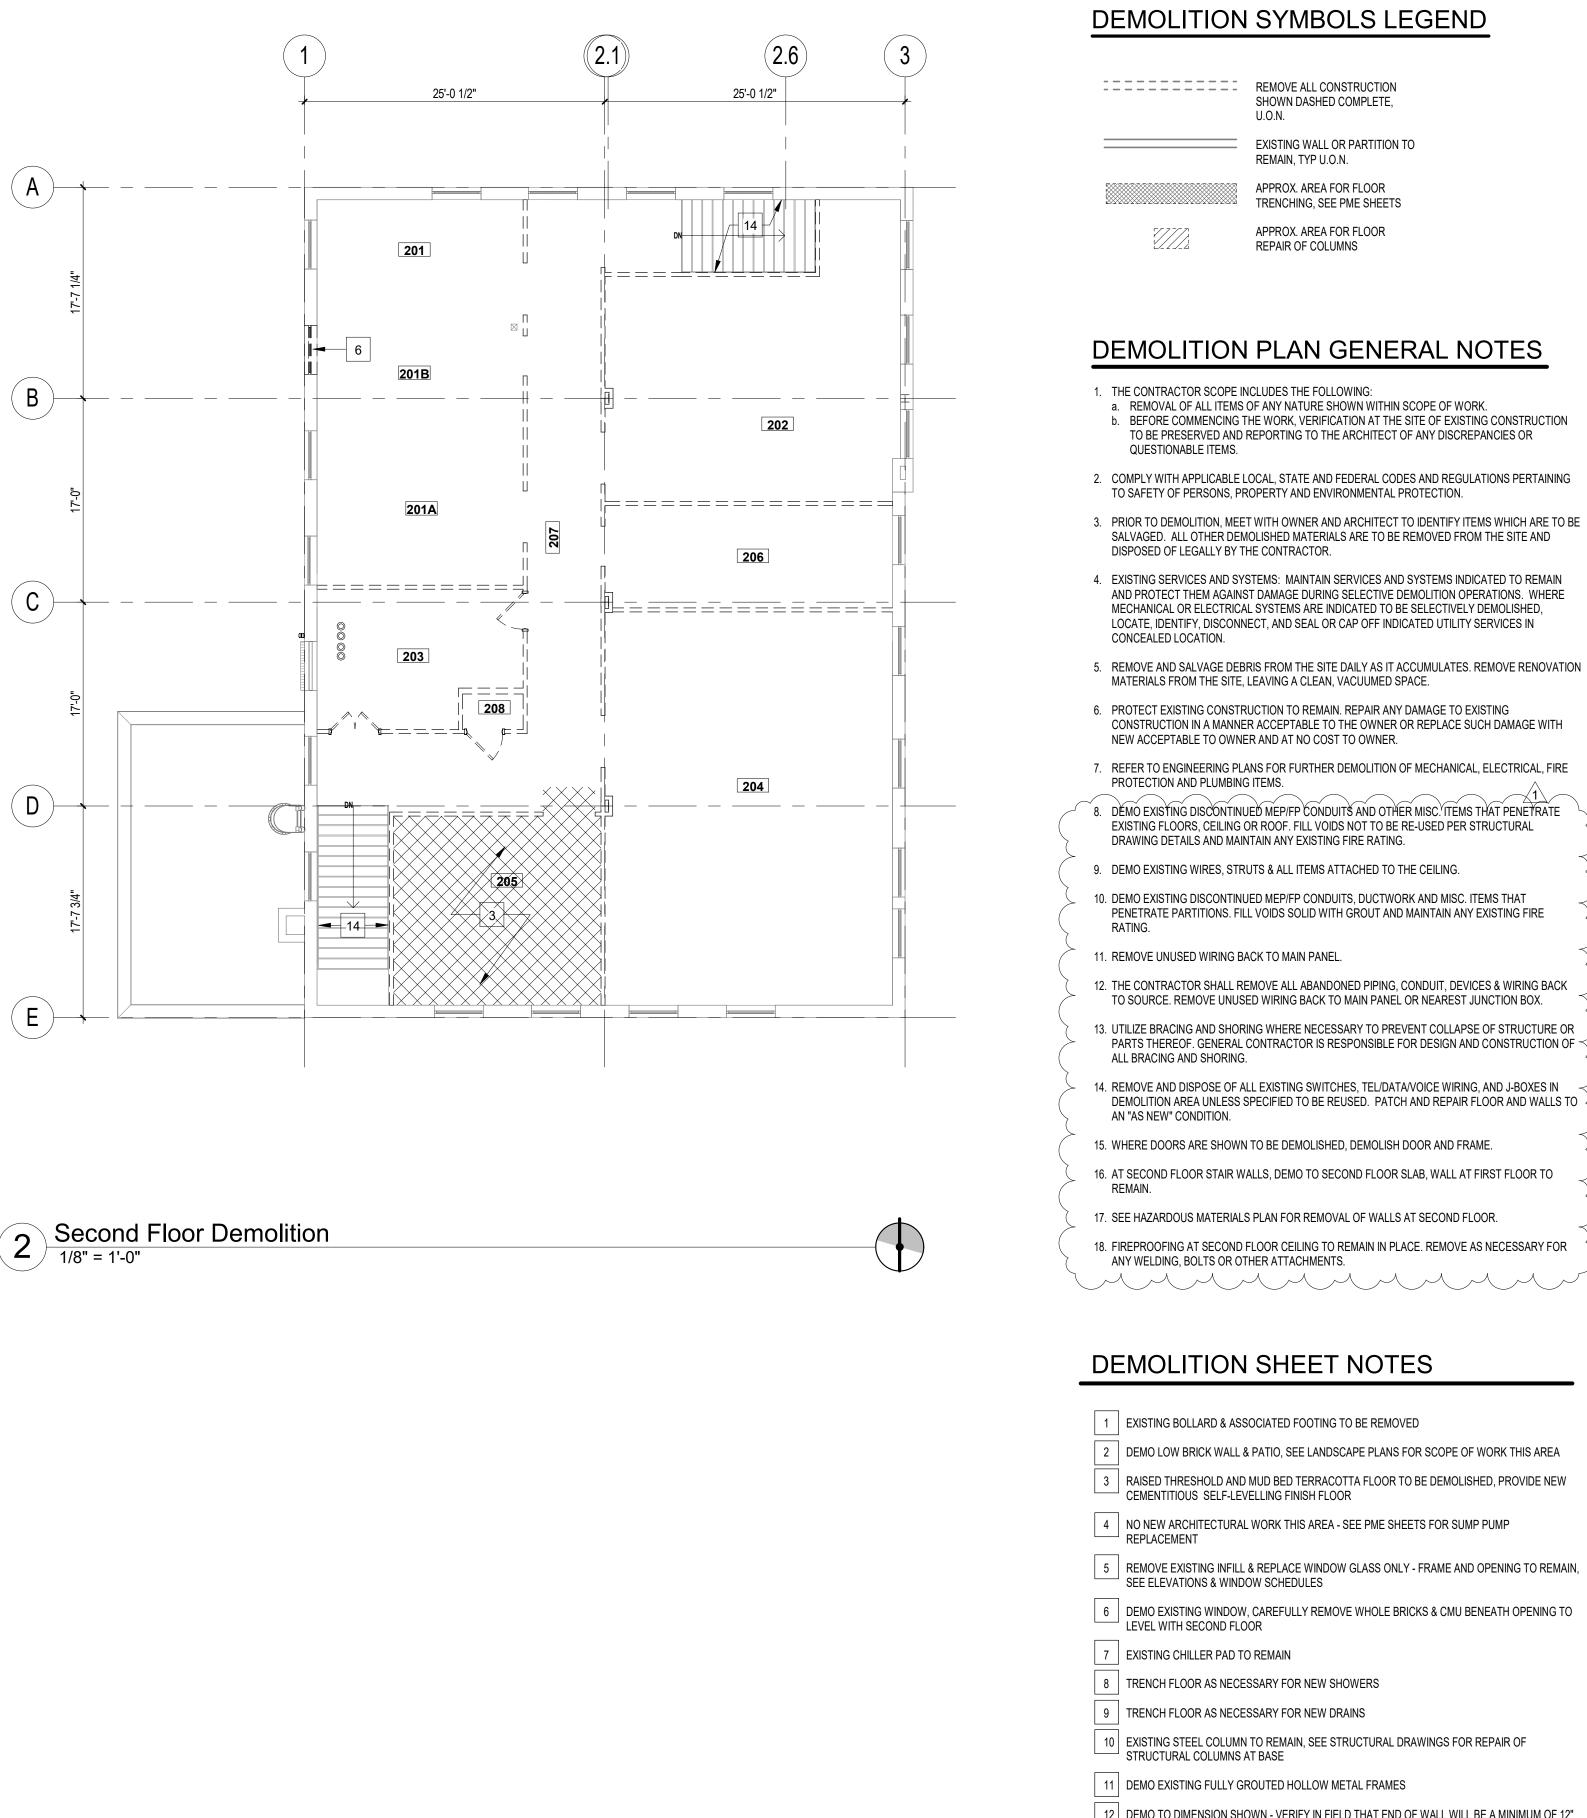


LOADING DOCK

NEW VARSITY

**EXISTING** CHILLER

PAD

13

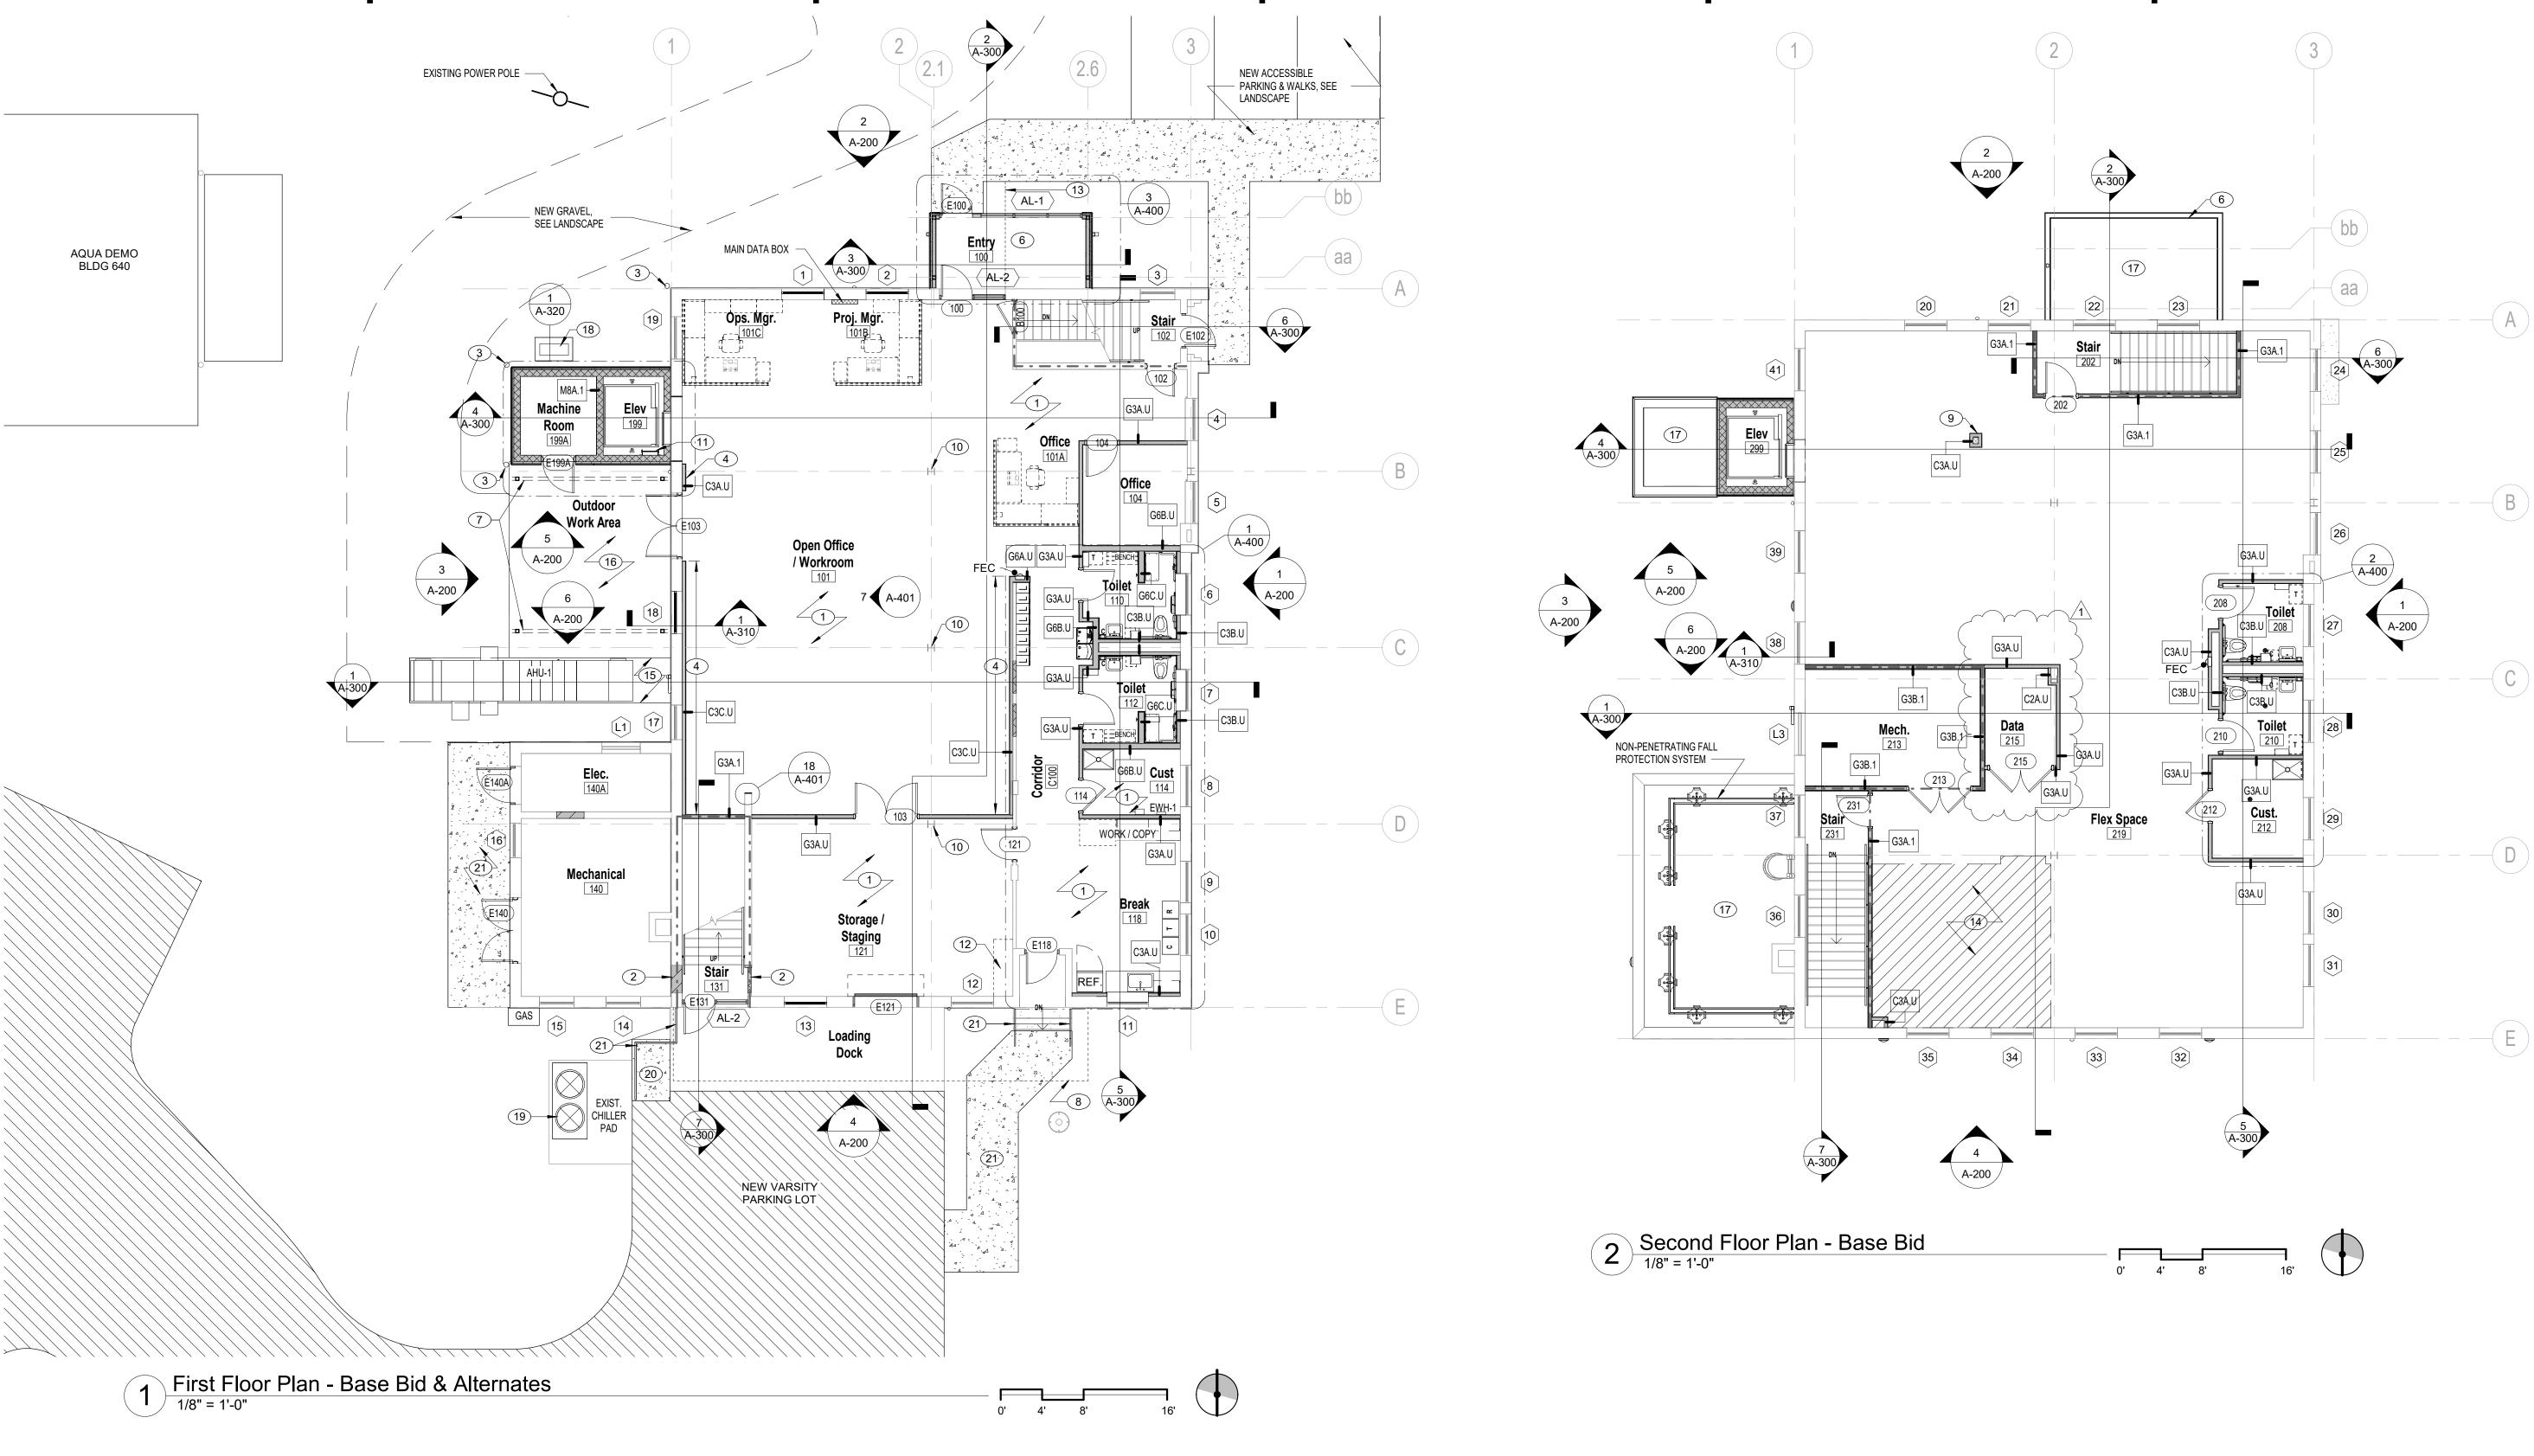

# CONSTRUCTION PLAN GENERAL NOTES

- 1. ANY CONFLICTS BETWEEN SITE CONDITIONS AND DRAWINGS SHALL BE BROUGHT TO THE IMMEDIATE ATTENTION
- 2. THE CONTRACT DOCUMENTS ARE COMPLIMENTARY TO EACH OTHER. WHAT IS REQUIRED FOR ONE DRAWING

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- SHALL BE AS BINDING AS IF REQUIRED FOR ALL.

  3. REVIEW LAYOUTS FOR PARTITIONS IN FIELD WITH ARCHITECT/DESIGNER PRIOR TO START OF CONSTRUCTION.

  4. ALL EXISTING WALLS TO REMAIN ARE TO BE PATCHED AND REPAIRED TO MEET REQUIREMENTS OF NEW FINISHES, U.O.N. REFER TO SPECIFICATIONS FOR LEVEL OF FINISH. EXISTING FIRE BARRIER WALLS ARE TO BE PATCHED AND REPAIRED TO MAINTAIN THE EXISTING FIRE RATING AS WELL AS MEET REQUIREMENTS OF NEW FINISHES.
- 5. PENETRATIONS IN GYPSUM BOARD CONSTRUCTION ABOVE FINISHED CEILING SHALL BE EFFECTIVELY SEALED TO PREVENT SOUND LEAKAGE AT ACOUSTICAL PARTITIONS AND AT DEMISING PARTITIONS, U.O.N.
- PROVIDE VERTICAL CONTROL JOINTS IN GWB EVERY 30'-0". VERIFY LOCATION WITH ARCHITECT U.O.N.
   PARTITIONS ARE DIMENSIONED FROM FACE OF STUD OR MASONRY UNLESS OTHERWISE NOTED. MAINTAIN
- DIMENSIONS MARKED "CLEAR" OR "HOLD". ALLOW FOR THICKNESS OF FINISHES.

  8. THE ARCHITECT RESERVES THE RIGHT TO MOVE ANY FIXTURE, RECEPTACLE OR BUILT-IN OBJECT UP UNTIL THE TIME HE/SHE SHALL APPROVE THE WALLS OR CEILINGS TO BE CLOSED. THIS APPROVAL SHALL TAKE PLACE PRIOR
- TO THE INSPECTORS APPROVAL SO AS NOT TO CONFLICT WITH ANY BUILDING OFFICIALS DECISIONS.

  9. PROVIDE FIRE EXTINGUISHERS (WITH RECESSED CABINETS) IN QUANTITIES AND LOCATIONS ON DWGS (MIN. 1/6000 SQ. FT. & 75' MAX TRAVEL DISTANCE). REVIEW FINAL LOCATIONS WITH THE ARCHITECT/DESIGNER PRIOR TO START OF CONSTRUCTION.
- OF CONSTRUCTION.

  10. MAINTAIN ALL FIRE ALARM DEVICES, HORNS AND STROBES DURING THE WORK.
- 11. PROTECT AREA OF WORK AND ADJACENT AREAS FROM DAMAGE DURING CONSTRUCTION.

  12. MAINTAIN WORK AREAS SECURE AND LOCKABLE DURING CONSTRUCTION. COORDINATE WITH OWNER TO ENSURE
- SECURITY.
- 13. DO NOT SCALE DRAWINGS. WRITTEN DIMENSIONS GOVERN. IN CASE OF CONFLICT, CONSULT THE ARCHITECT.
  14. ALL DOOR OPENINGS TO BE 4" FROM NEAREST PERPENDICULAR PARTITION, U.O.N.

15. SEE EXISTIING ELEVATION SHEET D-101 FOR WORK ASSOCIATED WITH EXISTING WINDOWS.

# PLAN KEY NOTES

- 1 PATCH AND REPAIR EXISTING CONCRETE FLOOR TO SMOOTH FINISH, SEAL AS SPECIFIED
- INFILL IN WALL TO MATCH EXISTING & ALIGN W/ WALL & WINDOW MAINTAIN ONE HOUR FIRE RATING
- 3 NEW BOLLARD, SEE LANDSCAPE FOR DETAILS
- WALL FOR EQUIPMENT TESTING, RUN IN FRONT OF EXISTING WINDOWS 6'-6" TO TOP OF STUD, WRAP EXPOSED ENDS TO MATCH FACE
- WALL FOR EQUIPMENT TESTING 7'-6" TO TOP OF STUD
- 6 BASE BID: NO NEW ENTRY VESTIBULE, NEW DOOR AT DOOR 100 ONLY ALTERNATE 4: PROVIDE NEW ENTRY VESTIBULE
- BASE BID: NO CANOPY AT OUTDOOR WORK AREA
  ALTERNATE 6: PROVIDE PRE-MANUFACTURED FREESTANDING METAL CANOPY (14'x15'x11' HIGH) AT OUTDOOR
- 8 BASE BID: NO CANOPY AT LOADING DOCK
- 9 WRAP EXISTING DATA CHASE TO 8'-6" A.F.F.

**WORK AREA** 

- REPAIR EXISTING COLUMN & PATCH FLOOR @ COLUMN AS REQUIRED FOR FLUSH, SMOOTH CONDITION SEE STRUCTURAL PLANS FOR COLUMN REPAIRS
- PROVIDE STEEL PIT ACCESS LADDER, COORDINATE LOCATION WITH FINAL ELEVATOR INSTALLATION
- NEW BACKFLOW PREVENTER IN EXISTING LOCATION


ALTERNATE 5: PROVIDE NEW CANOPY AT LOADING DOCK

- 13 EXTENT OF NEW SIDEWALK FOR BASE BID
- HATCH INDICATES APPROX. EXTENT OF NEW CEMENTITIOUS SELF-LEVELLING FINISH FEATHER FLUSH TO EXISTING FLOOR
- 15 EQUIPMENT PAD, SEE PME SHEETS
  - CANOPY PAD, SEE "L" SHEETS
  - OFF DOOF DIAMA 405 FOR ALL DOOFS & ASSOCIATED DETAILS
  - SEE ROOF PLAN A-105 FOR ALL ROOFS & ASSOCIATED DETAILS
  - MINI-SPLIT SYSTEM OUTDOOR UNIT, SEE MECHANICAL PLANS
- NEW CHILLER ON EXISTING PAD, SEE MECHANICAL PLANS
- NEW CONCRETE PAD, SEE LANDSCAPE PLANS

  BASE BID: NO WORK THIS AREA
  ALTERNATE 4: PROVIDE NEW CONCRETE AT THESE AREAS AS SHOWN, SEE "L" SHEETS
- FOR DETAILS.

  22 NEW HANDRAIL

# LEGEND

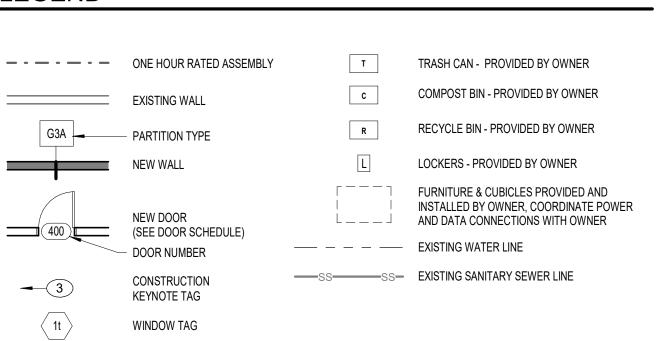

FIRE EXTINGUISHER RECESSED

CABINET, SEE 2/G004

PANTON AS SOLUTION AS SOLUTION



SCO ID# 19-21547-02A

NCSU ID 201920037

# date note

I 12/05/2023 Rev.


n E. Ellis Building (133) novations


PROJECT 1368-20
DATE 11/20/2023
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sheet name

Plans - Notational

**A-100** 



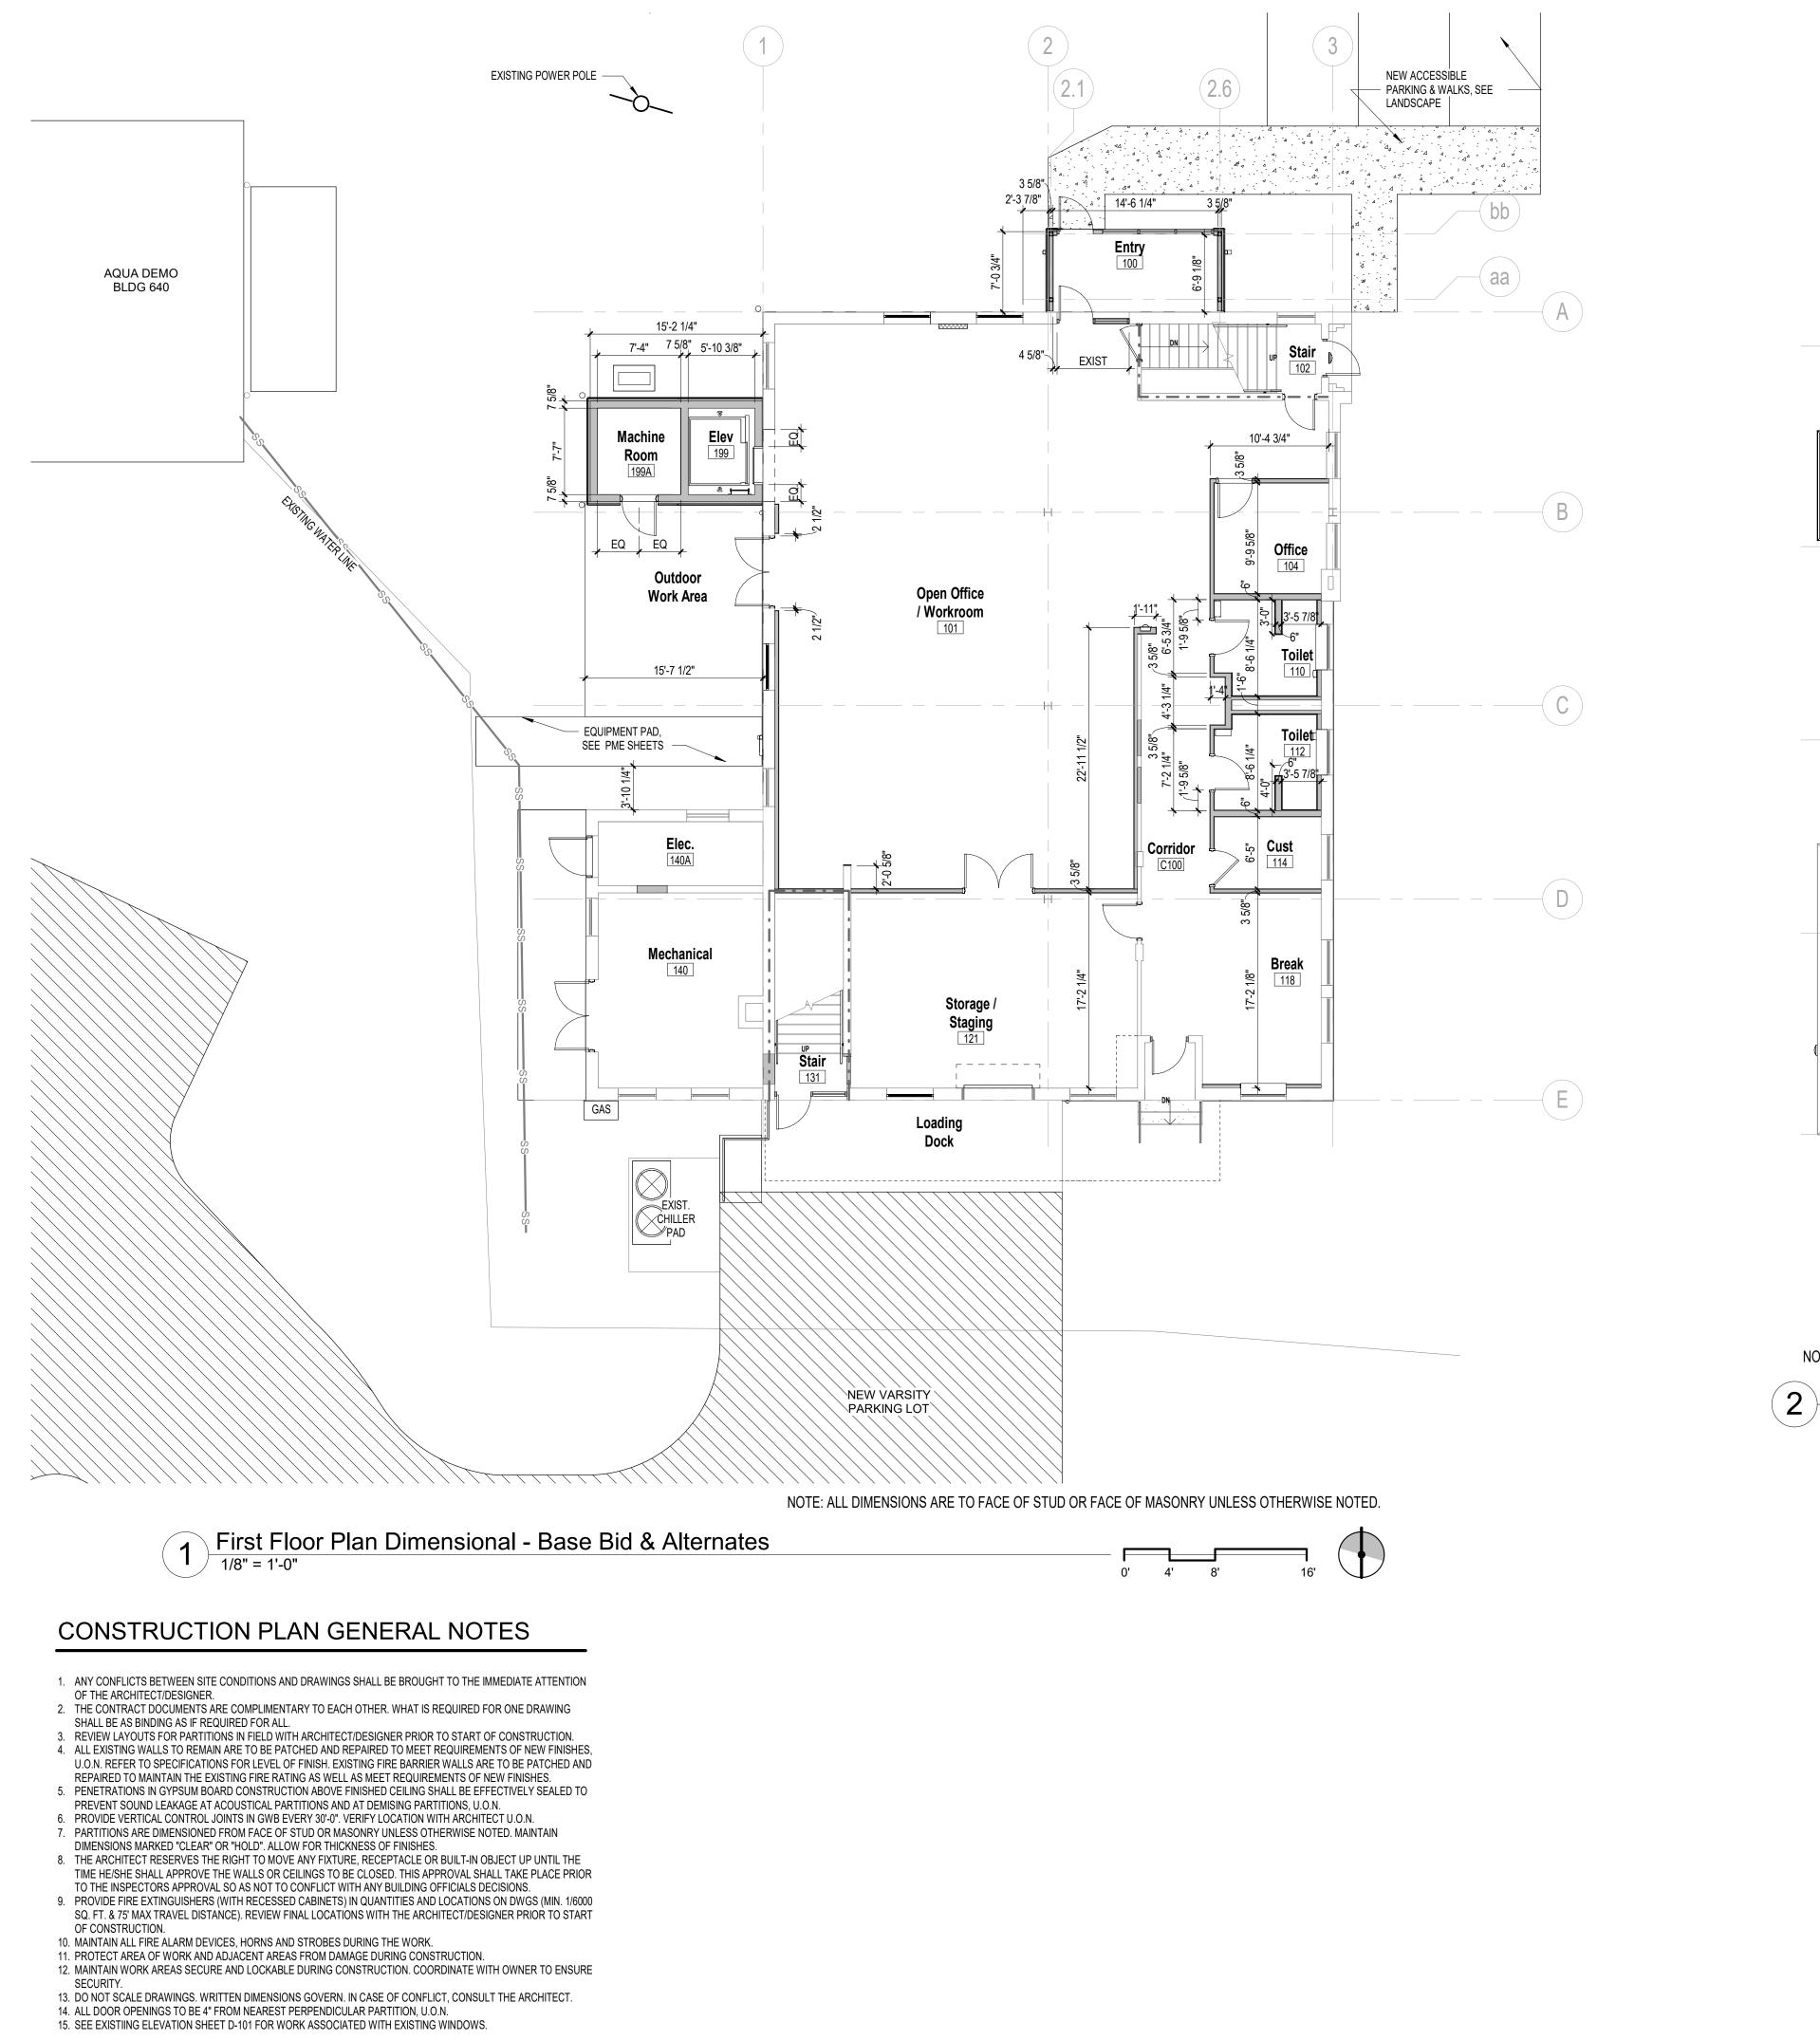


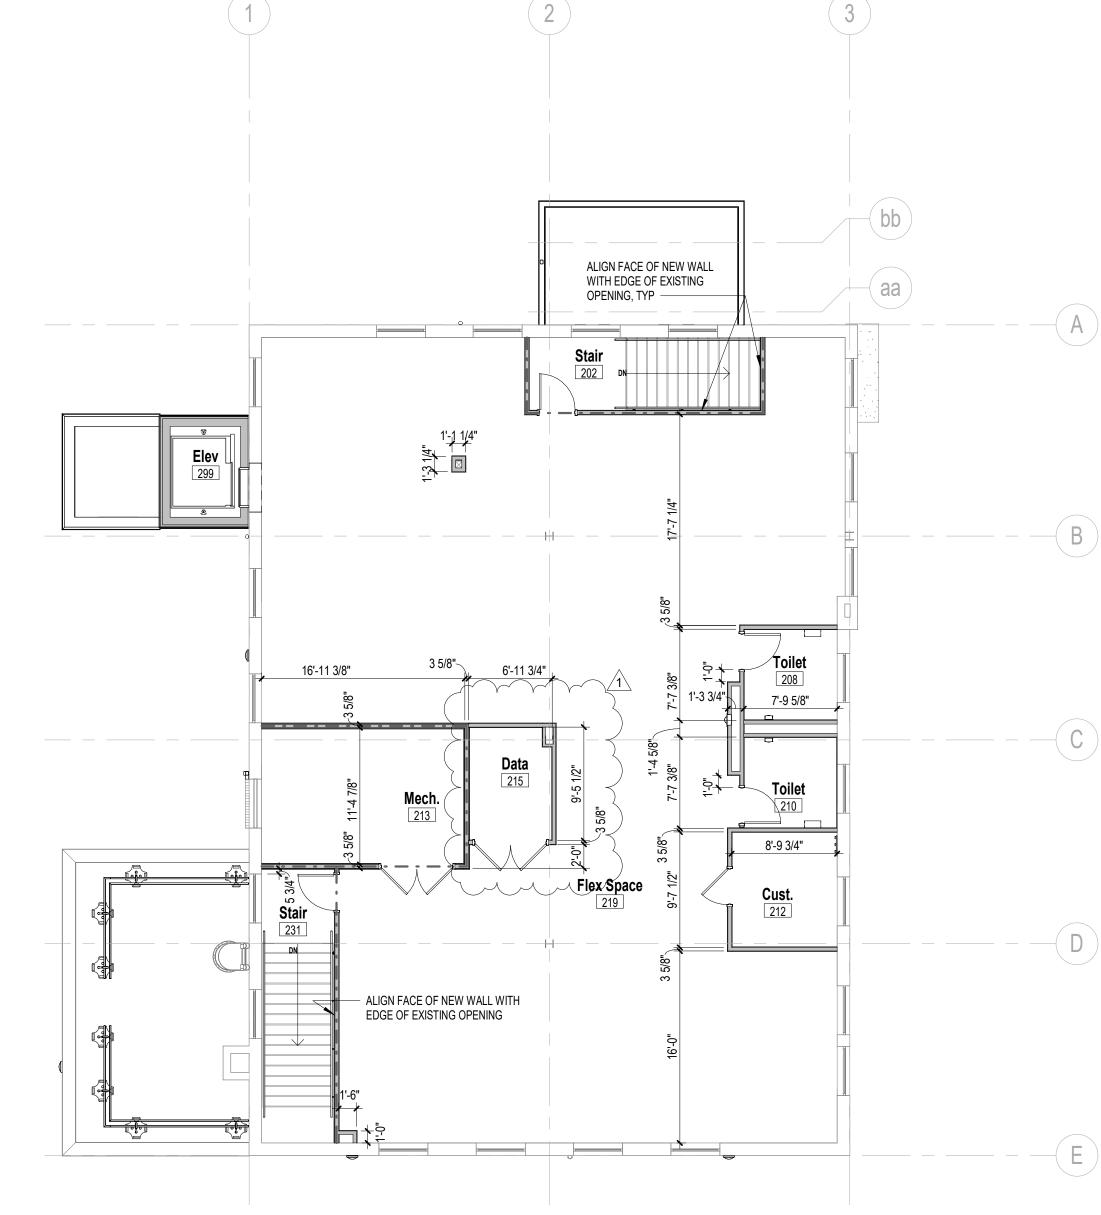NOTE: ALL DIMENSIONS ARE TO FACE OF STUD OR FACE OF MASONRY UNLESS OTHERWISE NOTED.

2 Second Floor Plan Dimensional - Base Bid

1/8" = 1'-0"

LEGEND

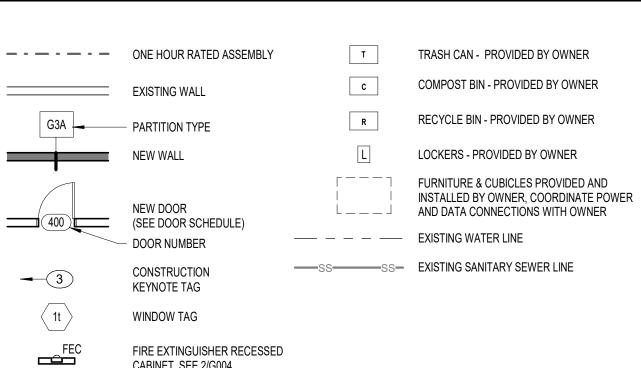

Building

PROJECT **1368-20**DATE **11/20/2023** DRAWN **ADQ** CHECKED ALK sheet name


SCO ID# 19-21547-02A

NCSU ID 201920037

I 12/05/2023 Rev.

Plans - Dimensional


CABINET, SEE 2/G004

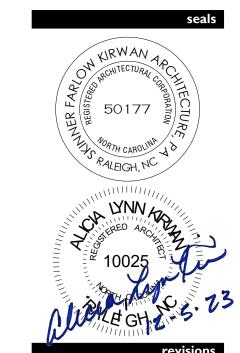

I 12/05/2023 Rev.



2 Second Floor RCP - Base Bid
1/8" = 1'-0"

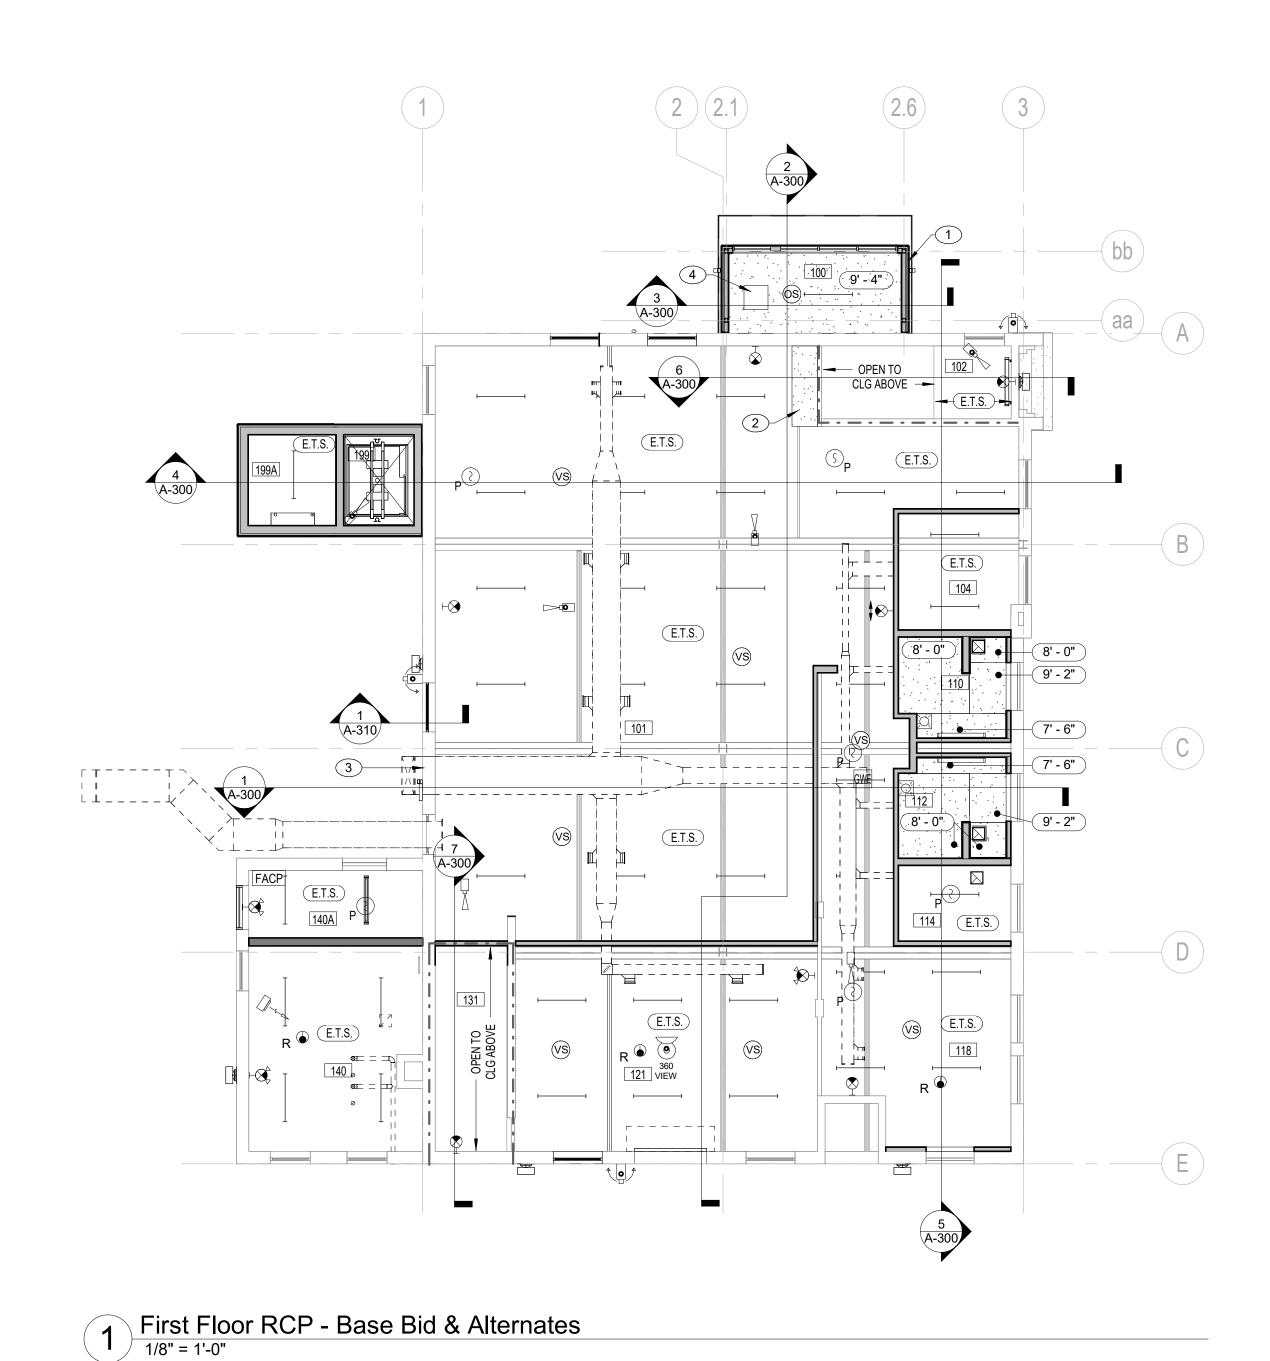


# REFLECTED CEILING PLAN GENERAL NOTES

- 1. THIS PLAN IS FOR CEILING FIXTURE AND EQUIPMENT LOCATIONS ONLY. REFER TO MEP/FP DRAWINGS FOR ADDITIONAL
- 2. ALL SMOKE DETECTORS, SPRINKLER HEADS, EXIT SIGNS, ETC. TO BE CENTERED IN CEILING TILE, U.O.N.
- 3. DOWNLIGHTS TO BE CENTERED, IN BOTH DIRECTIONS, IN ALL ACOUSTICAL CEILING TILES, U.O.N.
- 4. ALL DIMENSIONS OF FIXTURES, DEVICES, SPRINKLER HEADS, ETC. ARE TO CENTERLINE OF FIXTURE, U.O.N. WHERE ITEMS ARE IN LINE, CENTERLINE OF ITEMS OR GROUP OF ITEMS ARE TO ALIGN, U.O.N.
- 5. ACT CEILING IS TO BE CENTERED IN ALL ROOMS, U.O.N. REFER TO CEILING LAYOUT FOR GRID LINE OR TILE TO BE CENTERED.
- 6. ALL MEP/FP LOCATIONS IN CONFLICT WITH ARCHITECTURAL DRAWINGS SHOULD BE COORDINATED WITH THE ARCHITECT PRIOR TO INSTALLATION. NOTIFY ARCHITECT OF ANY DISCREPANCY, OMISSION, OR UNANTICIPATED FIELD CONDITION THAT ALTERS THE
- 7. ALL CEILING SYSTEMS SHALL BE SUPPORTED INDEPENDENT OF ALL NEW AND EXISTING PIPES, DUCTS, CONDUITS, ETC.
- 8. CEILING HEIGHT SHALL BE UNIFORM THROUGHOUT UNLESS OTHERWISE NOTED ON DRAWINGS.
- 9. ALL CEILING HEIGHTS ARE ABOVE FINISH FLOOR, WHERE THE FINISH FLOOR EQUALS 0'-0".
- 10. SHOP DRAWINGS ARE REQUIRED FOR ALL SPECIALTY CEILING SYSTEMS.
- 11. FINISH OF HVAC DIFFUSERS, DRAPERY POCKETS AND SPEAKER GRILLS TO MATCH ADJACENT FINISH, UNLESS OTHERWISE NOTED.
- 12. COORDINATE ALL CEILING ACCESS PANEL LOCATIONS WITH ARCHITECT PRIOR TO INSTALLATION.

# REFLECTED CEILING SHEET NOTES

- 1 BASE BID: NO NEW ENRY VESTIBULE ALTERNATE 4: NEW ENTRY VESTIBULE
- 2 SLOPED RATED BULKHEAD, SEE 6/A-300
- NEW OPENING FOR HVAC IN EXISTING MASONRY WALL, REFERENCE STRUCTURAL DRAWINGS AND
- 4 CEILING ACCESS PANEL, SEE SPECIFICATIONS PART OF ALTERNATE 4

# REFLECTED CEILING LEGEND

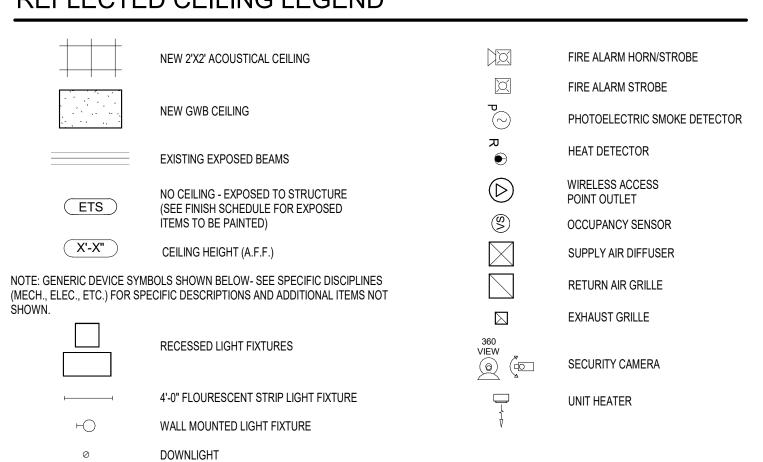

PROJECT **1368-20** DATE 11/20/2023 DRAWN ADQ CHECKED ALK


Building


Reflected Ceiling Plan

sheet name

I 12/05/2023 Rev.

Building

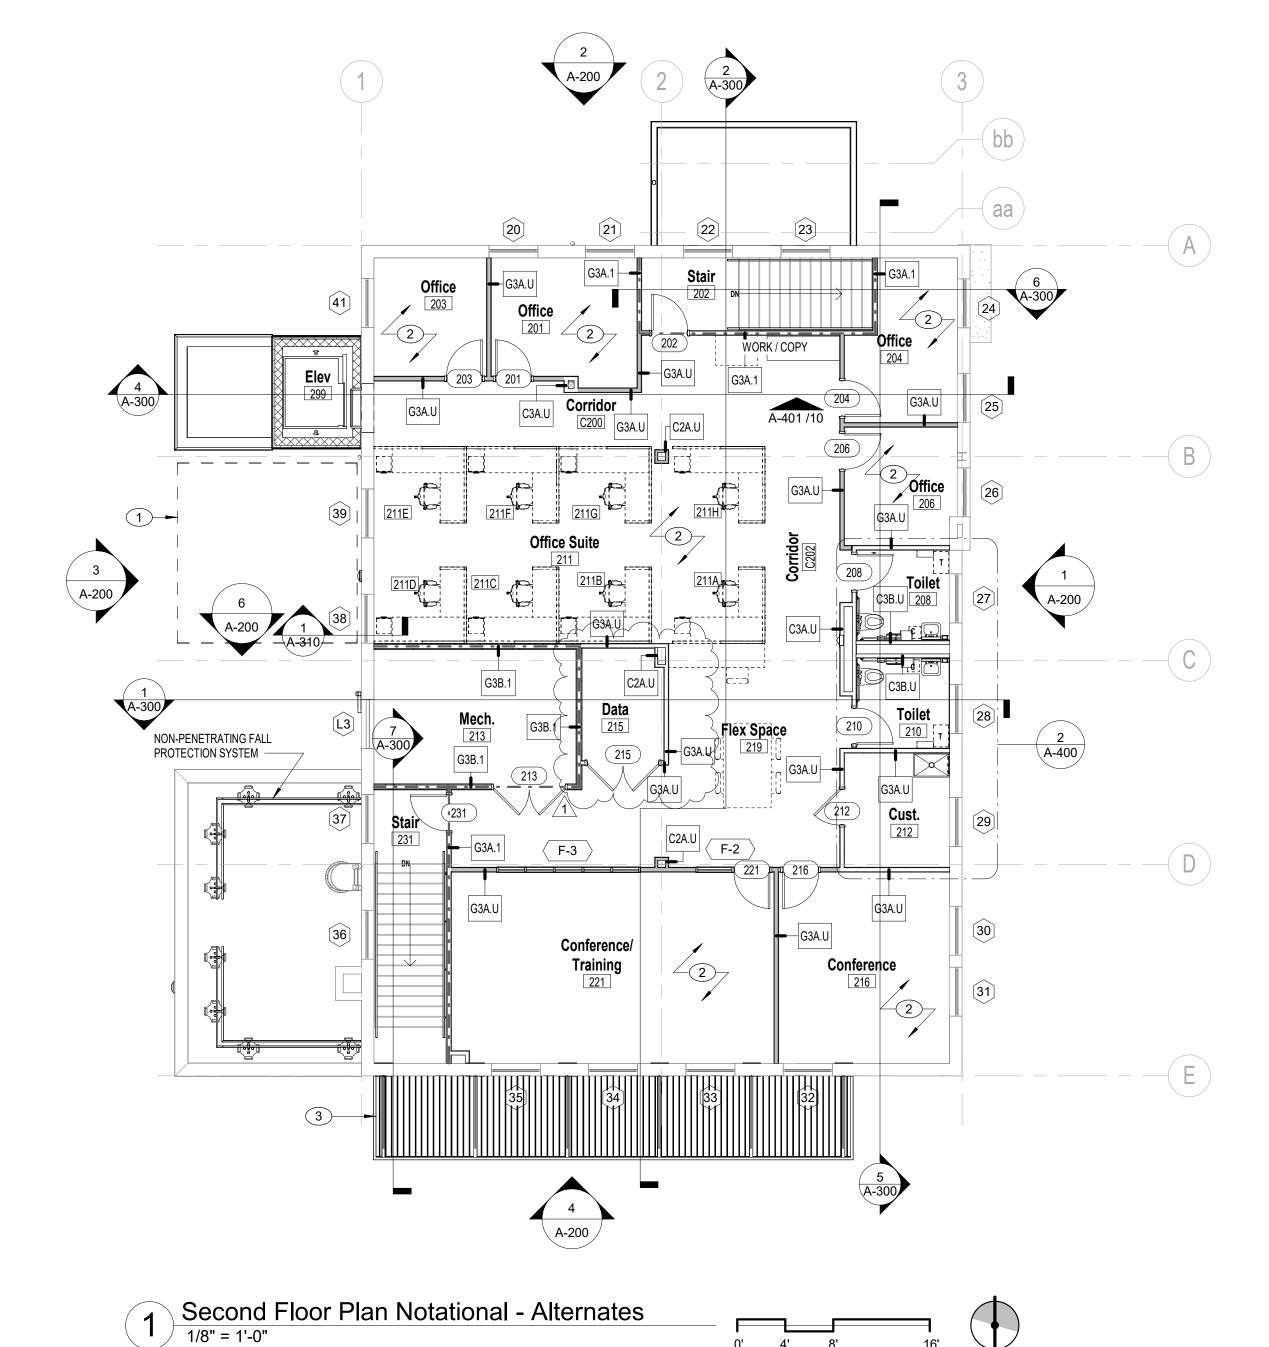

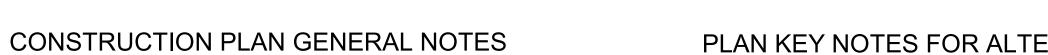

- 1. ANY CONFLICTS BETWEEN SITE CONDITIONS AND DRAWINGS SHALL BE BROUGHT TO THE IMMEDIATE ATTENTION
- OF THE ARCHITECT/DESIGNER. 2. THE CONTRACT DOCUMENTS ARE COMPLIMENTARY TO EACH OTHER. WHAT IS REQUIRED FOR ONE DRAWING
- SHALL BE AS BINDING AS IF REQUIRED FOR ALL. 3. REVIEW LAYOUTS FOR PARTITIONS IN FIELD WITH ARCHITECT/DESIGNER PRIOR TO START OF CONSTRUCTION. 4. ALL EXISTING WALLS TO REMAIN ARE TO BE PATCHED AND REPAIRED TO MEET REQUIREMENTS OF NEW FINISHES,
- U.O.N. REFER TO SPECIFICATIONS FOR LEVEL OF FINISH. EXISTING FIRE BARRIER WALLS ARE TO BE PATCHED AND REPAIRED TO MAINTAIN THE EXISTING FIRE RATING AS WELL AS MEET REQUIREMENTS OF NEW FINISHES.
- 5. PENETRATIONS IN GYPSUM BOARD CONSTRUCTION ABOVE FINISHED CEILING SHALL BE EFFECTIVELY SEALED TO PREVENT SOUND LEAKAGE AT ACOUSTICAL PARTITIONS AND AT DEMISING PARTITIONS, U.O.N.
- 6. PROVIDE VERTICAL CONTROL JOINTS IN GWB EVERY 30'-0". VERIFY LOCATION WITH ARCHITECT U.O.N.
- 7. PARTITIONS ARE DIMENSIONED FROM FACE OF STUD OR MASONRY UNLESS OTHERWISE NOTED. MAINTAIN DIMENSIONS MARKED "CLEAR" OR "HOLD". ALLOW FOR THICKNESS OF FINISHES. 8. THE ARCHITECT RESERVES THE RIGHT TO MOVE ANY FIXTURE, RECEPTACLE OR BUILT-IN OBJECT UP UNTIL THE
- TIME HE/SHE SHALL APPROVE THE WALLS OR CEILINGS TO BE CLOSED. THIS APPROVAL SHALL TAKE PLACE PRIOR TO THE INSPECTORS APPROVAL SO AS NOT TO CONFLICT WITH ANY BUILDING OFFICIALS DECISIONS. 9. PROVIDE FIRE EXTINGUISHERS (WITH RECESSED CABINETS) IN QUANTITIES AND LOCATIONS ON DWGS (MIN. 1/6000 SQ. FT. & 75' MAX TRAVEL DISTANCE). REVIEW FINAL LOCATIONS WITH THE ARCHITECT/DESIGNER PRIOR TO START
- OF CONSTRUCTION. 10. MAINTAIN ALL FIRE ALARM DEVICES, HORNS AND STROBES DURING THE WORK.
- 11. PROTECT AREA OF WORK AND ADJACENT AREAS FROM DAMAGE DURING CONSTRUCTION.
- 12. MAINTAIN WORK AREAS SECURE AND LOCKABLE DURING CONSTRUCTION. COORDINATE WITH OWNER TO ENSURE
- 13. DO NOT SCALE DRAWINGS. WRITTEN DIMENSIONS GOVERN. IN CASE OF CONFLICT, CONSULT THE ARCHITECT. 14. ALL DOOR OPENINGS TO BE 4" FROM NEAREST PERPENDICULAR PARTITION, U.O.N. 15. SEE EXISTIING ELEVATION SHEET D-101 FOR WORK ASSOCIATED WITH EXISTING WINDOWS.

# PLAN KEY NOTES FOR ALTERNATES

- 1 PROVIDE PRE-MANUFACTURED FREESTANDING METAL CANOPY AT OUTDOOR WORK AREA


HANGER ROD SUPPORTS

2 NEW CARPET AND BASE NEW PRE-ENGINEERED SUSPENDED METAL CANOPY, BASIS OF DESIGN MAPES SUPER LUMIDECK W/

### LEGEND TRASH CAN - PROVIDED BY OWNER — - — - — ONE HOUR RATED ASSEMBLY COMPOST BIN - PROVIDED BY OWNER EXISTING WALL / BASE BID WALL RECYCLE BIN - PROVIDED BY OWNER PARTITION TYPE FURNITURE & CUBICLES PROVIDED AND ALTERNATE WALL INSTALLED BY OWNER, COORDINATE POWER $\sqcup - - - \sqcup$ AND DATA CONNECTIONS WITH OWNER (SEE DOOR SCHEDULE) — DOOR NUMBER CONSTRUCTION KEYNOTE TAG WINDOW TAG FIRE EXTINGUISHER RECESSED CABINET, SEE 2/G004

Second Floor RCP - Alternates

1/8" = 1'-0"

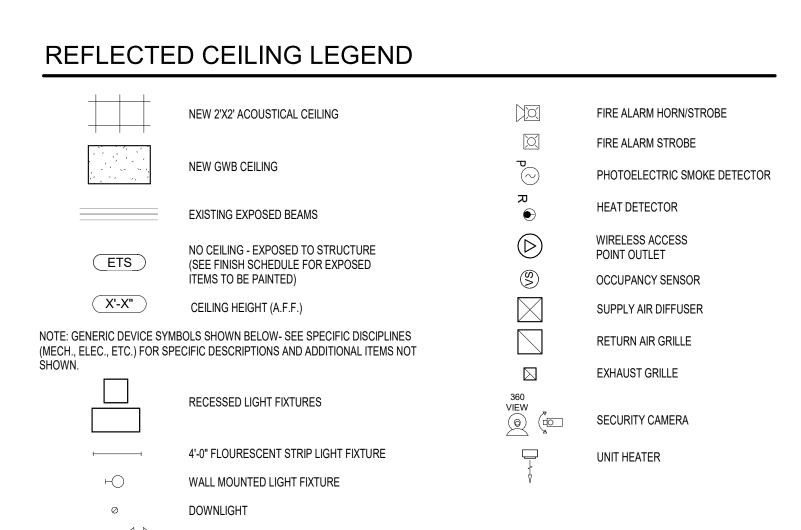

EXIT SIGN

Floor Alternates

sheet name

PROJECT **1368-20** 

DRAWN **ADQ** 

CHECKED ALK

DATE 11/20/2023

Plan & RCP - Second

I 12/05/2023 Rev.


Second Floor Plan Dimensional - Alternates

1/8" = 1'-0"

26'-11 3/4"

LEGEND

NOTE: ALL DIMENSIONS ARE TO FACE OF STUD OR FACE OF MASONRY UNLESS OTHERWISE NOTED.

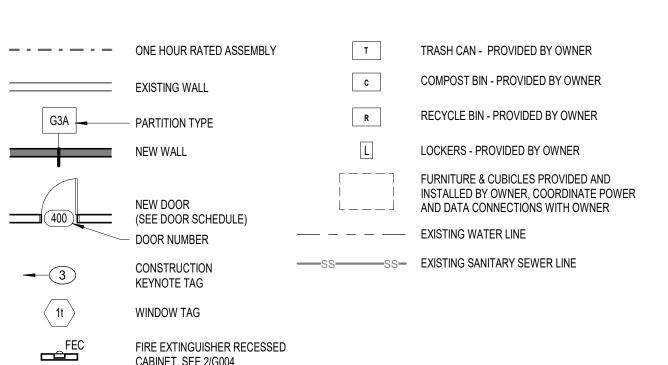

# CONSTRUCTION PLAN GENERAL NOTES

- 1. ANY CONFLICTS BETWEEN SITE CONDITIONS AND DRAWINGS SHALL BE BROUGHT TO THE IMMEDIATE ATTENTION
- 2. THE CONTRACT DOCUMENTS ARE COMPLIMENTARY TO EACH OTHER. WHAT IS REQUIRED FOR ONE DRAWING SHALL BE AS BINDING AS IF REQUIRED FOR ALL.
- 3. REVIEW LAYOUTS FOR PARTITIONS IN FIELD WITH ARCHITECT/DESIGNER PRIOR TO START OF CONSTRUCTION. 4. ALL EXISTING WALLS TO REMAIN ARE TO BE PATCHED AND REPAIRED TO MEET REQUIREMENTS OF NEW FINISHES, U.O.N. REFER TO SPECIFICATIONS FOR LEVEL OF FINISH. EXISTING FIRE BARRIER WALLS ARE TO BE PATCHED AND
- REPAIRED TO MAINTAIN THE EXISTING FIRE RATING AS WELL AS MEET REQUIREMENTS OF NEW FINISHES. 5. PENETRATIONS IN GYPSUM BOARD CONSTRUCTION ABOVE FINISHED CEILING SHALL BE EFFECTIVELY SEALED TO
- PREVENT SOUND LEAKAGE AT ACOUSTICAL PARTITIONS AND AT DEMISING PARTITIONS, U.O.N. 6. PROVIDE VERTICAL CONTROL JOINTS IN GWB EVERY 30'-0". VERIFY LOCATION WITH ARCHITECT U.O.N.
- 7. PARTITIONS ARE DIMENSIONED FROM FACE OF STUD OR MASONRY UNLESS OTHERWISE NOTED. MAINTAIN DIMENSIONS MARKED "CLEAR" OR "HOLD". ALLOW FOR THICKNESS OF FINISHES.
- 8. THE ARCHITECT RESERVES THE RIGHT TO MOVE ANY FIXTURE, RECEPTACLE OR BUILT-IN OBJECT UP UNTIL THE TIME HE/SHE SHALL APPROVE THE WALLS OR CEILINGS TO BE CLOSED. THIS APPROVAL SHALL TAKE PLACE PRIOR TO THE INSPECTORS APPROVAL SO AS NOT TO CONFLICT WITH ANY BUILDING OFFICIALS DECISIONS.
- 9. PROVIDE FIRE EXTINGUISHERS (WITH RECESSED CABINETS) IN QUANTITIES AND LOCATIONS ON DWGS (MIN. 1/6000 SQ. FT. & 75' MAX TRAVEL DISTANCE). REVIEW FINAL LOCATIONS WITH THE ARCHITECT/DESIGNER PRIOR TO START
- OF CONSTRUCTION. 10. MAINTAIN ALL FIRE ALARM DEVICES, HORNS AND STROBES DURING THE WORK.
- 11. PROTECT AREA OF WORK AND ADJACENT AREAS FROM DAMAGE DURING CONSTRUCTION.
- 12. MAINTAIN WORK AREAS SECURE AND LOCKABLE DURING CONSTRUCTION. COORDINATE WITH OWNER TO ENSURE
- 13. DO NOT SCALE DRAWINGS. WRITTEN DIMENSIONS GOVERN. IN CASE OF CONFLICT, CONSULT THE ARCHITECT.
- 14. ALL DOOR OPENINGS TO BE 4" FROM NEAREST PERPENDICULAR PARTITION, U.O.N. 15. SEE EXISTIING ELEVATION SHEET D-101 FOR WORK ASSOCIATED WITH EXISTING WINDOWS.

PROJECT **1368-20** 

DRAWN **ADQ** 

CHECKED ALK

DATE 11/20/2023

Plans - Second Floor

**Dimensional - Alternates** 

sheet name

CABINET, SEE 2/G004

216 14'-3 5/8"

Building

NEW WALK-THROUGH HANDRAILS
 @ ROOF ACCESS LADDER, WELD
 TO EXISTING

NEW CMU HOISTWAY WITH METAL PANEL CLADDING

Roof (B.O.D.) 22' - 3"

Second 10' - 9"

Basement -8' - 6"

SCO ID# 19-21547-02A NCSU ID 201920037

I 12/05/2023 Rev.

Roof (B.O.D.) 22' - 3"

Second 10' - 9"

NON-PENETRATIONG FALL PROTECTION SYSTEM

- ALTERNATE: FREESTANDING

- EXISTING ACCESS HATCH TO

METAL CANOPY

REMAIN

North Elevation @ Electrical Room


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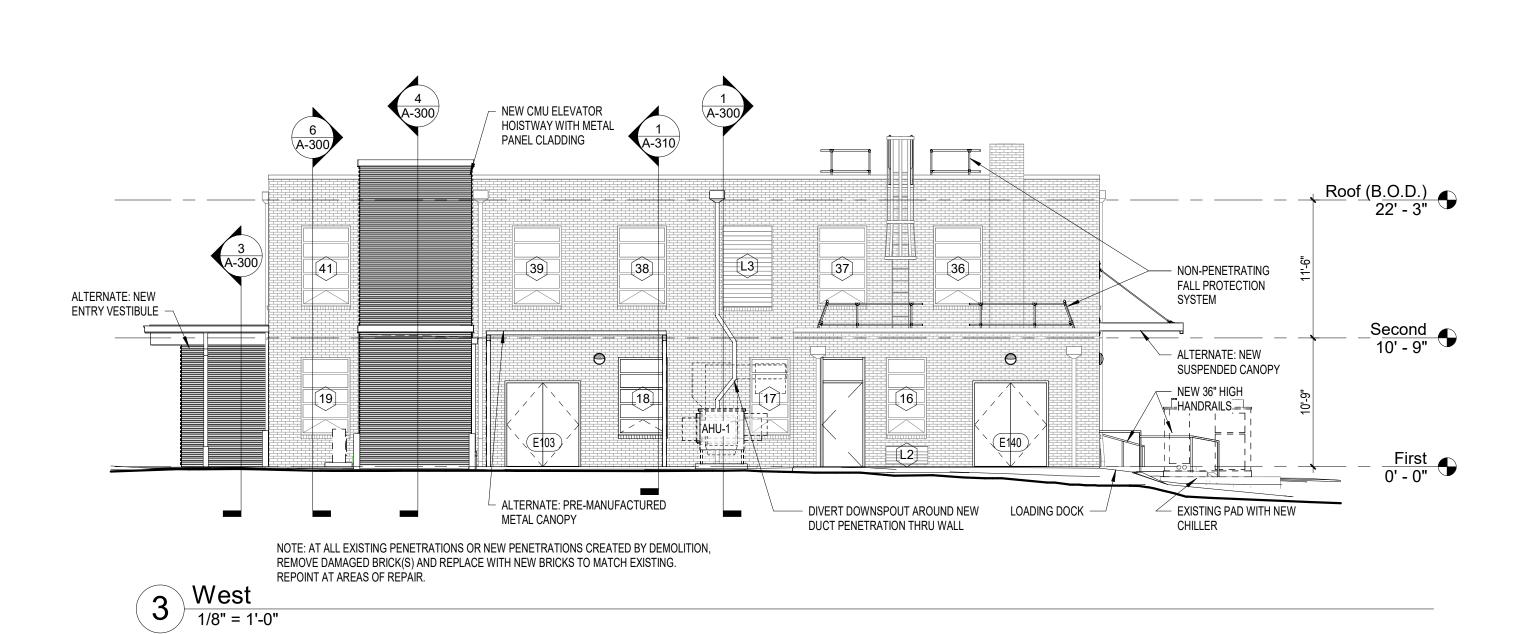
**Exterior Elevations** 

PROJECT 1368-20
DATE 11/20/2023
DRAWN ADQ
CHECKED ALK


sheet name

Ellis Building (133)



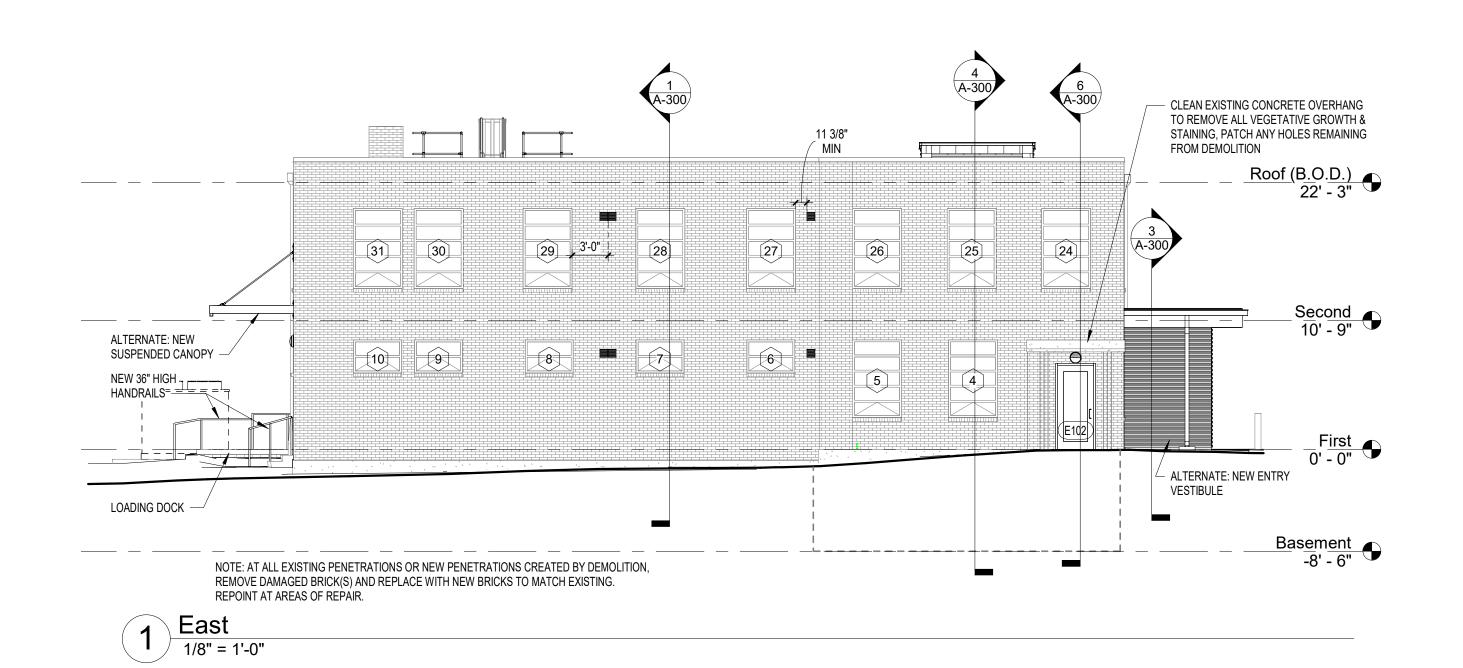


E

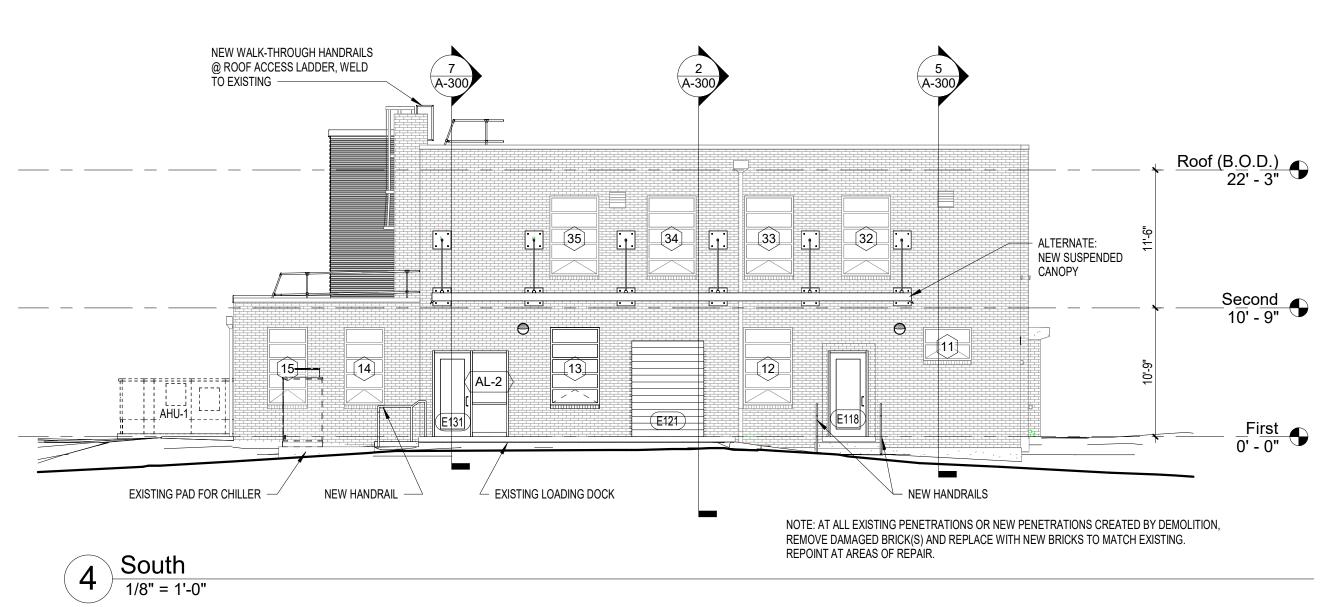

EXCAVATE @ EXISTING STORM DRAIN & LOCATE
UNCONNECTED DRAINPIPE - PROVIDE NEW PIPING
& CONNECT DOWNSPOUT TO EXISTING DRAIN


NOTE: AT ALL EXISTING PENETRATIONS OR NEW PENETRATIONS CREATED BY DEMOLITION, REMOVE DAMAGED BRICK(S) AND REPLACE WITH NEW BRICKS TO MATCH EXISTING. REPOINT AT AREAS OF REPAIR.

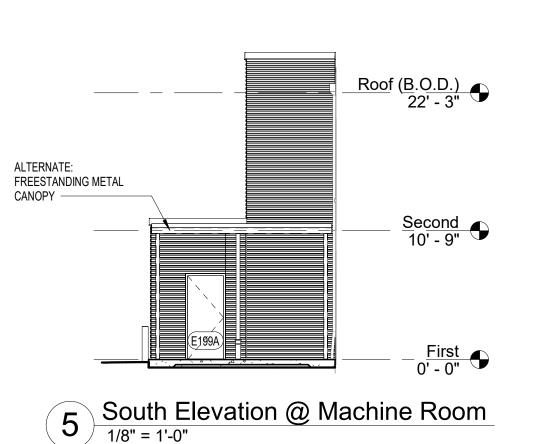

ALTERNATE: NEW ENTRY VESTIBULE

CLEAN EXISTING CONCRETE LINTEL ——

North
1/8" = 1'-0"

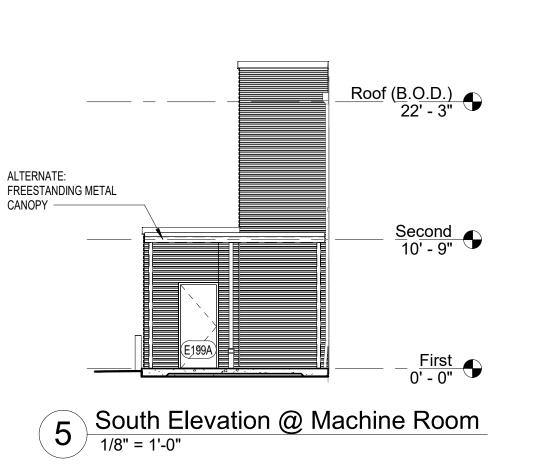



ACCENT PAINT -

ACCENT PAINT

ACCENT PAINT

ACCENT

ACCENT -

ACCENT PAINT -

213

2 Second Floor Finish Plan - Base
1/8" = 1'-0"

213

3 Second Floor Finish Plan - Base + Alternates

1/8" = 1'-0"

SCO ID# 19-21547-02A NCSU ID 201920037

I 12/05/2023 Rev. I

Ellis Building (133)

PROJECT **1368-20**DATE **11/20/2023** DRAWN **MKW** CHECKED ALK

**A-700** 




First Floor Finish Plan - Base + Alternates

1/8" = 1'-0"







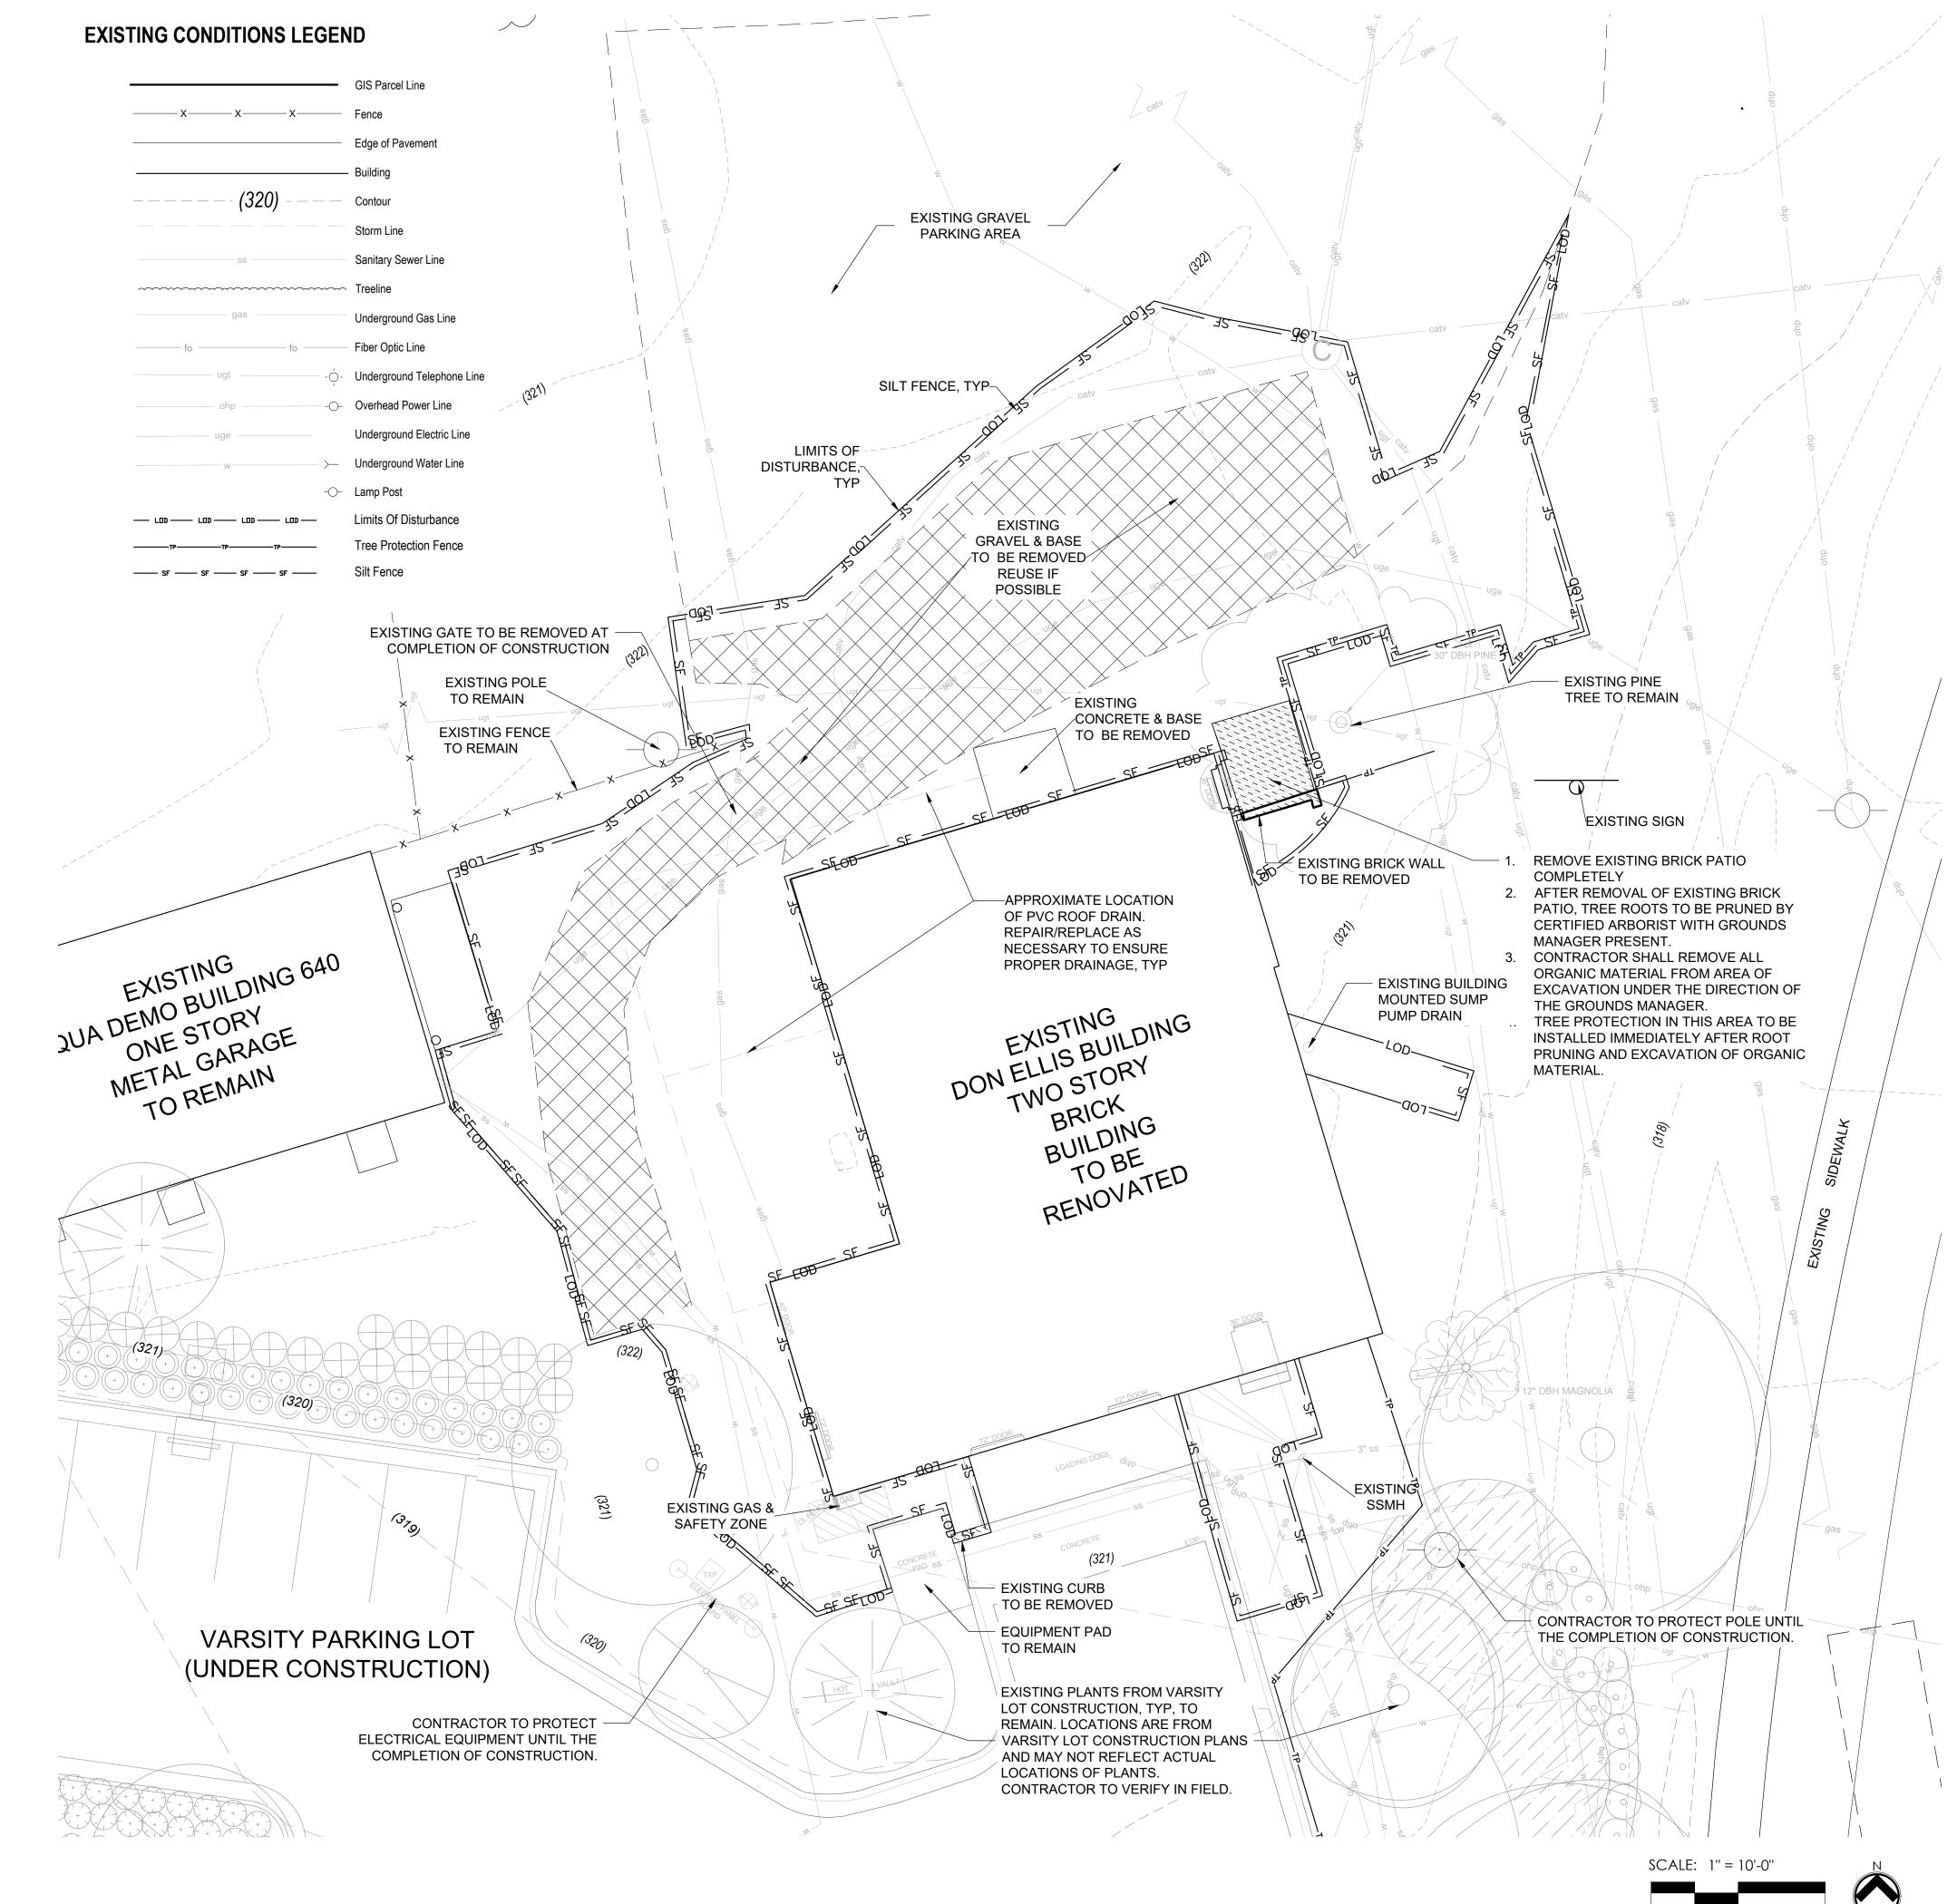

### PROPERTY DATA

- CURRENT OWNER: NORTH CAROLINA STATE UNIVERSITY
- 2. SITE ADDRESS: 1350 VARSITY DRIVE, RALEIGH, NC 27606
- 3. PIN: 794507874
- 4. DEED REFERENCE: DB 125 PG145
- 5. TOTAL SITE AREA: APPROXIMATELY 12.73 AC (SURVEYED)
- 6. AREA OF DISTURBANCE: 7,387 SF

# **EXISTING CONDITIONS NOTES**

- 1. PROPERTY LINES ARE FROM WAKE COUNTY GIS.
- 2. UTILITY SURVEY (SUE) INFORMATION PROVIDED BY NCSU DATED 09/06/23.
- EXISTING CONDITIONS & TOPOGRAPHIC INFORMATION PROVIDED BY NCSU ON 03/16/22. ADDITIONAL TOPOGRAPHIC INFORMATION PROVIDED BY NCSU ON 10/2/23. VERTICAL DATUM AND COORDINATE SYSTEM NAD83 (2011).
- 4. FINISHED FLOOR ELEVATIONS PROVIDED BY SURVEY BY DRAPER ADEN ON 10/05/22.
- 5. PROPOSED BUILDING PLANS PROVIDED BY SKINNER FARLOW KIRWAN ON 10/05/23.
- 6. PROJECT PROPERTY DOES NOT LIE WITHIN A SPECIAL FLOOD HAZARD AREA AS REFERENCED BY FEMA FLOOD INSURANCE RATE MAP NO. 3720079300K, EFFECTIVE DATE 7/19/2022.

### **DEMOLITION NOTES**

- 1. THE CONTRACTOR SHALL NOTIFY THE N.C. ONE CALL CENTER AT 811 OR 1-800-632-4949 PRIOR TO STARTING WORK.
- 2. THE CONTRACTOR SHALL NOTIFY THE LOCAL GOVERNING PUBLIC UTILITIES DEPARTMENT PRIOR TO STARTING WORK.
- 3. ALL DEMOLITION, AND ANY SUBSEQUENT CONSTRUCTION, SHALL BE PERFORMED IN ACCORDANCE WITH THESE PLANS AND SPECIFICATIONS SET FORTH AND APPROVED BY THE LOCAL GOVERNING MUNICIPALITY OR THE STATE. THE CONTRACTOR IS RESPONSIBLE FOR OBTAINING ALL REQUIRED PERMITS.
- 4. THE CONTRACTOR SHALL NOT MAKE ANY LANE CLOSURES OR CHANGES TO THE EXISTING TRAVEL PATTERNS ON ANY PUBLIC STREET WITHOUT PRIOR APPROVAL FROM THE LOCAL GOVERNING MUNICIPALITY TRANSPORTATION DEPARTMENT AND/OR STATE TRANSPORTATION DEPARTMENT.
- LOCAL GOVERNING MUNICIPALITY AND/OR STATE DEPARTMENT OF TRANSPORTATION PRIOR TO ANY CONSTRUCTION IN PUBLIC RIGHT-OF-WAY.
- . THE CONTRACTOR IS RESPONSIBLE FOR CONFORMING TO ALL LOCAL, STATE AND FEDERAL REQUIREMENTS REGARDING REMOVAL AND DISPOSAL OF MATERIALS AND DEBRIS.

LANE CLOSURE, TRAFFIC CONTROL PLAN, OR PEDESTRIAN CONTROL PLAN TO BE COORDINATED WITH APPROPRIATE STAFF OF THE

- 7. CONTRACTOR SHALL REFER TO CIVIL SHEETS FOR SANITARY SEWER AND WATER REMOVALS AND RELOCATIONS.
- 8. RELOCATION OF EXISTING UTILITIES TO BE COORDINATED WITH THE LOCAL UTILITY PROVIDER(S).
- 9. WHERE UTILITIES (TO BE REMOVED) IMPACT THE FOOTPRINT OF THE NEW BUILDING, CONTRACTOR SHALL EXCAVATE AND REMOVE AN ADDITIONAL 2 FEET OF SOILS TO EITHER SIDE OF PIPE, AND 1 FOOT BELOW TO REMOVE UNSUITABLE SOILS, IF UNSUITABLE SOILS EXIST.
- CLEANOUTS LOCATED IN AREAS OF DEMOLITION OR SUBSEQUENT CONSTRUCTION THAT ARE TO REMAIN, SHALL BE PROTECTED FROM DAMAGE AND RAISED TO FLUSH WITH NEW GRADE.
- 11. ELECTRICAL OR GAS UTILITY SERVICES TO BE REMOVED SHALL BE REMOVED AND RELOCATED (AS INDICATED) BY THE UTILITY PROVIDER. CONTRACTOR SHALL SCHEDULE AND COORDINATE THIS WORK WITH THE APPROPRIATE SERVICE PROVIDER. ALL SERVICES SHOULD BE RE-INSTALLED PRIOR TO THE INSTALLATION OF PAVEMENT, SIDEWALKS, CURB AND GUTTER, OR OTHER PERMANENT FEATURES.
- 12. REMOVE EXISTING CONCRETE (WHERE REQUESTED) TO FIRST COLD JOINT OR SAWCUT JOINT TO OBTAIN A CLEAN EDGE FOR NEW CONSTRUCTION. SAWCUT EXISTING ASPHALT DRIVE AT LIMITS OF NEW CURBING TO OBTAIN A CLEAN EDGE.
- 13. CONTRACTOR SHALL RETAIN AND STOCKPILE CONCRETE WHEELSTOPS WHICH ARE IN USEABLE CONDITION FOR RE-INSTALLATION
- 14. CONTRACTOR SHALL RESTORE THE LAYDOWN AND STAGING AREA TO ORIGINAL CONDITIONS AND TO THE SATISFACTION OF THE OWNER, PRIOR TO DEMOBILIZATION AT THE CONCLUSION OF THE PROJECT.
- 15. CLEAN SOILS SHALL BE UTILIZED FOR BACKFILL. COMPACTION OF THESE SOILS PERFORMED IN ACCORDANCE WITH SPECIFICATIONS, GEOTECHNICAL REPORT, AND SITE PLAN.
- 16. ALL FENCING TO BE REMOVED SHALL BE REMOVED AT NEXT NEAREST POLE.

AT THE END OF THE PROJECT.

- 17. ALL GRAVEL TO BE REMOVED (SURFACE OR SUBSURFACE) SHALL BE STOCKPILED AND REUSED ON SITE WHERE POSSIBLE.
- 18. ALL ITEMS DESIGNATED TO BE REMOVED SHALL BE REMOVED COMPLETELY, INCLUDING ALL SUBGRADE MATERIALS DIRECTLY ASSOCIATED WITH ITEMS TO BE REMOVED.
- 19. ALL ITEMS DESIGNATED TO BE REMOVED SHALL BE DISPOSED OF LEGALLY OFFSITE UNLESS OTHERWISE NOTED ON THIS PLAN.
- 20. ALL TREES TO BE REMOVED SHALL BE GROUND DOWN TO A MINIMUM DEPTH OF 12" BELOW PROPOSED FINISH GRADE.
- 21. ALL TREE PROTECTION FENCING SHALL REMAIN IN PLACE DURING DEMOLITION AND CONSTRUCTION.
- 22. CONTRACTOR SHALL NOT STOCKPILE SOILS OR CONSTRUCTION EQUIPMENT WITHIN ROOT ZONES OF EXISTING TREES TO REMAIN. ANY DAMAGED TREES SHALL BE REPLACED AT CONTRACTOR'S EXPENSE.

| Farlow | Kirw



919.805.3586 **project status** 

Construction
Documents for BID

SCO ID# 19-21547-02A NCSU # 201920037

seals

X AROUND C-505 X X S ARCHING AROUND A

revisions
I 12.05.23 BID ADDENDUM


Don E. Ellis Building (133) Renovations

PROJECT 1368-20
DATE 10/16/2023
DRAWN DB
CHECKED LM

EXISTING
CONDITIONS &
DEMOLITION PLAN

sheet name

L-100

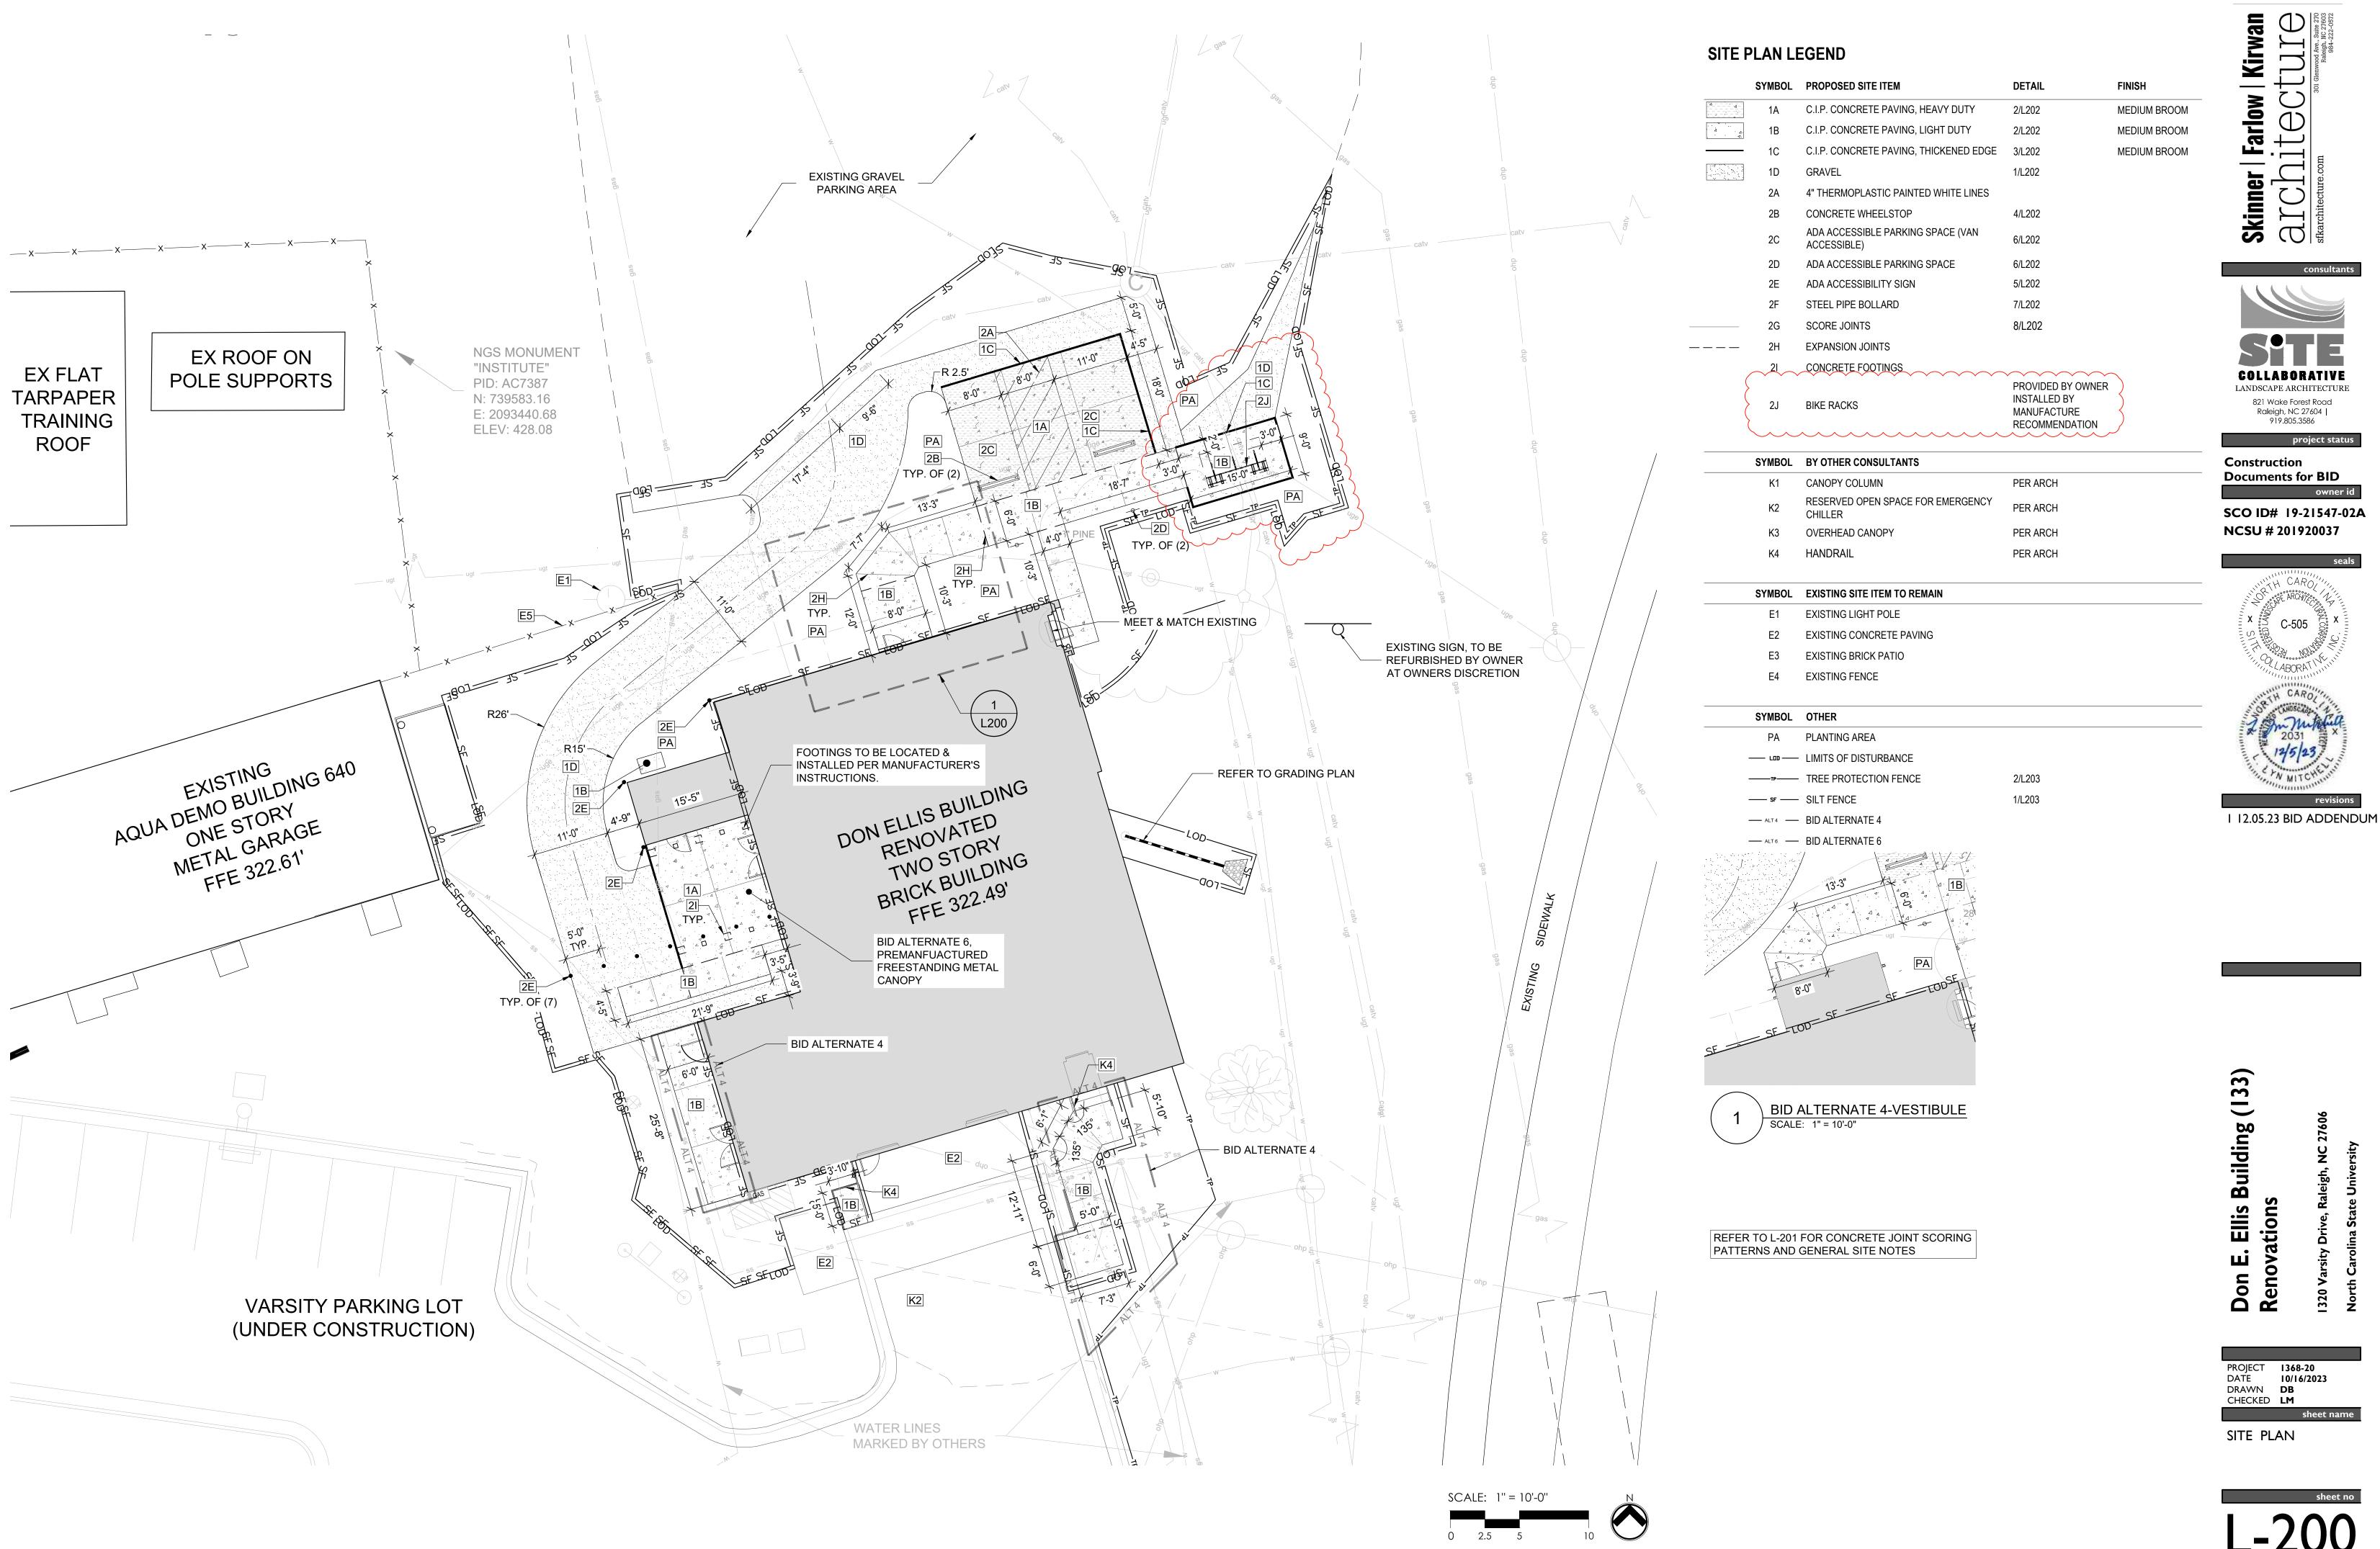

E. Ellis Building (133) vations Don E. Renova

821 Wake Forest Road Raleigh, NC 27604 | 919.805.3586

PROJECT 1368-20
DATE 10/16/2023
DRAWN DB
CHECKED LM

SITE PLAN

L-200



# **GRADING NOTES**

- ORIGINAL EXISTING CONDITIONS SHOWN AS 'EXISTING' IN THIS PLAN SET HAS BEEN COMPILED FROM SURVEY DATA PROVIDED BY WAKE IMAPS. CONTRACTOR TO FIELD VERIFY ALL INFORMATION AND REPORT ANY DISCREPANCIES.
- 2. ALL DIMENSIONS AND GRADES SHOWN ON THE PLANS SHALL BE FIELD VERIFIED BY THE CONTRACTOR PRIOR TO CONSTRUCTION. CONTRACTOR SHALL NOTIFY LANDSCAPE ARCHITECT IF ANY DISCREPANCIES EXIST PRIOR TO PROCEEDING WITH CONSTRUCTION FOR NECESSARY PLAN OR GRADE CHANGES. NO EXTRA COMPENSATION SHALL BE PAID TO CONTRACTOR FOR ANY WORK DONE DUE TO DIMENSIONS OR GRADES SHOWN INCORRECTLY ON THESE PLANS IF SUCH NOTIFICATION HAS NOT BEEN GIVEN.
- 3. ALL PAVEMENTS TO SLOPE POSITIVELY AWAY FROM ALL BUILDINGS. PONDING OF WATER IS PROHIBITED.
- 4. THE GENERAL CONTRACTOR IS RESPONSIBLE FOR MAINTENANCE OF EROSION CONTROL METHODS DURING CONSTRUCTION, AND THE OWNER IS RESPONSIBLE FOR MAINTENANCE OF ALL PERMANENT EROSION CONTROL METHODS AFTER CONSTRUCTION IS COMPLETE, IF ANY PERMANENT METHODS ARE REQUIRED.
- 5. CONSTRUCTION AND MAINTENANCE OF ALL EROSION CONTROL DEVICES SHALL CONFORM TO THE STANDARDS SET FORTH IN THE CITY OF RALEIGH EROSION AND SEDIMENT CONTROL MANUAL.
- 6. INSPECTOR REFERS TO AUTHORIZED REGULATORY AGENCY SEDIMENTATION AND EROSION CONTROL INSPECTOR OR HIS/HER REPRESENTATIVE. FIELD INSPECTIONS MAY REQUIRE ADDITIONAL SEDIMENTATION AND EROSION CONTROL MEASURES AS DEEMED NECESSARY BY THE INSPECTOR, CLIENT, AND/OR CLIENT'S REPRESENTATIVES.
- 7. WHEN HAND PLANTING, MULCH (HAY OR STRAW) SHOULD BE UNIFORMLY SPREAD OVER SEEDED AREA WITHIN 24 HOURS OF SEEDING.
- 8. DURING UNSUITABLE GROWING SEASONS, MULCH WILL BE USED AS A TEMPORARY COVER ON SLOPES THAT ARE 4:1 OR STEEPER, MULCH WILL BE ANCHORED.
- 9. EROSION AND SEDIMENT CONTROL DEVICES MUST BE INSTALLED AND INSPECTED PRIOR TO ANY GRADING
- ON SITE. PLEASE CALL THE REGULATORY AUTHORITY FOR AN INSPECTION.
- RAINFALL (0.5 INCHES OR GREATER) AND DOCUMENT WITH INSPECTION REPORTS.

10. INSPECT AND MAINTAIN ALL EROSION CONTROL MEASURES EVERY 7 DAYS AND AFTER EACH SIGNIFICANT

- 11. EACH DEVICE IS TO BE MAINTAINED OR REPLACED IF SEDIMENT ACCUMULATION HAS REACHED ONE HALF THE CAPACITY OF THE DEVICE.
- 12. LOCATE STOCKPILES UPSLOPE FROM EROSION CONTROL MEASURES. ALL SOIL STOCK PILES SHALL HAVE APPROPRIATE EROSION CONTROL PER THE LATEST VERSION OF THE CITY OF RALEIGH EROSION AND SEDIMENT CONTROL MANUAL INCLUDING SEEDING AND SILT FENCE AROUND THE BASE OF THE STOCK PILE.





# **GRADING LEGEND**

GRADING LEGEND		
KEY	DESCRIPTION	
EX	EXISTING GRADE	
HP	HIGH POINT	
LP	LOW POINT	
FG	FIELD GRADE	
TP	TOP OF PIPE	
BP	BOTTOM OF PIPE	
< X%	SLOPE DIRECTION - POINTS DOWNWARD	
	ACCESSIBLE ROUTE	
LOD	LIMITS OF DISTURBANCE	
ТР	TREE PROTECTION FENCE	
— sr —	SILT FENCE	

A

nner | Farlow | Kirwan

Collitecture.com

Sol Glenwood Ave., Suite 270

Baleigh, NC 27603

Baleigh, NC 27603

Baleigh, NC 27603

consultants



project status

Construction
Documents for BID

SCO ID# 19-21547-02A NCSU # 201920037

x in C-505 Si X

I 12.05.23 BID ADDENDUM

Don E. Ellis Building (133) Renovations

PROJECT 1368-20
DATE 10/16/2023
DRAWN DB
CHECKED LM

GRADING PLAN

L-300

Autumn Moon Camellia

Nikko Blue Hydrangea

Nellie R. Stevens Holly

COMMON NAME

Pennsylvania Sedge

Foxtrot Fountain Grass

October Magic® Ruby™ Camellia

Camellia sasanqua 'Autumn Moon'

Camellia sasanqua 'Green 02-003'

|Hydrangea macrophylla 'Nikko Blue'

Pennisetum alopecuroides 'Foxtrot'

llex x 'Nellie R. Stevens'

BOTANICAL NAME

Carex pensylvanica

CC5

GROUND COVERS QTY

36" MIN.

24" MIN.

18" MIN.

HEIGHT

12" MIN.

12"

24" MIN, 5 GAL MIN.

SPREAD

12"

CONT. SIZE

FLAT

1 GAL.

Full, Dense, Upright

Plant when not dormant

Full, Dense

Full, Dense

Full, Dense

SPACING REMARKS

12" o.c.

30" o.c.

# PLANTING NOTES

- 1. NCSU SHALL PURCHASE AND INSTALL ALL PLANT MATERIAL.
- 2. TYPICAL DUMPSTER SCREENING TO BE LOCATED AND COORDINATED WITH LANDSCAPE ARCHITECT
- 3. ALL DISTURBED AREAS NOT WITHIN TRAFFIC AREAS SHALL RECEIVE SEED OR SOD.
- 4. ROUGH GRADING TO BE COMPLETED PRIOR TO THE START OF PLANT INSTALLATION. SUBSTANTIAL COMPLETION SIGN-OFF BY LANDSCAPE ARCHITECT CONTRACTOR TO ENSURE NO CHANNELIZED FLOWS AROUND THE SITE.
- 5. ALL DISTURBED AREAS SHALL BE SEEDED/SODDED WITH 'TIFTUF' BERMUDA GRASS PER THE SEEDING/SODDING NOTES BELOW.
- 6. CONTRACTOR RESPONSIBLE FOR LOCATING ALL UTILITIES AND UNDERGROUND IMPEDIMENTS PRIOR TO BEGINNING PLANTING.
- 7. ALL WEEDS, NON-NATIVE INVASIVE SPECIES, AND EXOTIC SPECIES LOCATED WITHIN THE PROJECT CONTRACTOR LIMITS SHALL BE ELIMINATED PRIOR TO PLANTING BED CREATION, PLANTING, AND SEEDING/SODDING OPERATIONS.
- 8. PLANTING SHOULD OCCUR IMMEDIATELY AFTER CONSTRUCTION TO STABILIZE AREAS OF BARE SOIL.
- 9. IT SHALL BE NOTED THAT ALL SECTIONS OF THE SITE THAT ARE SLOPED 3:1 OR HIGHER WILL BE COVERED WITH EROSION CONTROL STABILIZATION COIR FABRIC (WITH 1" SQUARE OPENINGS) PRIOR TO PLANTING TO ENSURE IMMEDIATE STABILIZATION. LANDSCAPE CONTRACTOR SHALL CUT FABRIC AT EACH PLANT LOCATION AND PLACE PLANTS ACCORDING TO PLAN. ALL FABRIC SHALL BE RE-STAKED PER ENGINEERS ORIGINAL DRAWINGS IMMEDIATELY AFTER PLANTING.
- 10.PLANTS ARE TO BE PURCHASED BY BOTANICAL NAMES. THEY SHALL BE REPRESENTATIVE OF THEIR SPECIES, MEET ALL NOTED CONDITIONS OF SPECIFICATIONS, AND SHALL BE IN VIGOROUS GROWING CONDITION MEETING ANSI STANDARD Z60.
- 11.LANDSCAPE ARCHITECT OR OWNER MAINTAINS RIGHT TO REJECT ANY PLANT DUE TO AESTHETICS OR STRUCTURAL DEFICIENCY AT ANY TIME.
- 12.CONTRACTOR RESPONSIBLE FOR FURNISHING AND INSTALLING ALL PLANTS SHOWN ON PLANS IN LOCATIONS SHOWN, QUANTITIES GIVEN ON THE PLANT LEGEND ARE FOR CONTRACTOR'S CONVENIENCE ONLY. IF DISCREPANCIES OCCUR, THE PLANS SHALL OVERRULE THE PLANT LEGEND. CONTRACTOR SHALL LOCATE ALL PLANTS AWAY FROM KNOWN PERMANENT FIXTURES. IF CONFLICT ARISES WITH PLAN, CONTRACTOR SHALL NOTIFY PROJECT MANAGER OR DESIGNEE PRIOR TO PROCEEDING.
- 13.ALL PLANT MATERIAL SHALL CONFORM TO OR EXCEED THE AMERICAN STANDARD FOR NURSERY STOCK (LATEST EDITION) AS PUBLISHED BY THE AMERICAN ASSOCIATION
- 14. ALL PLANT MATERIAL SHALL BE FREE OF ALL PESTS, DISEASES, AND CANKERS, IN HEALTHY CONDITION, AND FREE OF MECHANICAL DAMAGE AT THE TIME OF PLANTING.
- 15. IT IS THE RESPONSIBILITY OF THE CONTRACTOR TO ENSURE A HEALTHY AND VIABLE PLANT AND THE PLANT SHALL BE REJECTED IF DEEMED UNHEALTHY OR UNFIT AT ANY TIME DURING THE CONTRACT OR WARRANTY DURATION.
- 16. IF ANY PLANT/MATERIAL SUBSTITUTIONS ARE REQUESTED BY CONTRACTOR, THEN NOTICE SHALL BE GIVEN TO PROJECT MANAGER OR DESIGNEE AT MINIMUM SEVENTY-TWO (72) HOURS (NOT INCLUDING WEEKENDS) PRIOR TO DESIRED ORDERING DATE/TIME. WHEN SUBSTITUTIONS ARE REQUESTED BY CONTRACTOR, SUGGESTED ACCEPTABLE REPLACEMENTS SHALL ALSO BE PRESENTED AT TIME FOR FULL AND COMPLETE REVIEW BY LANDSCAPE ARCHITECT OR OWNER.
- 17. BALLED AND BURLAPPED PLANTS/TREES TO BE PLANTED PRIOR TO CONTAINER OR BEDDING PLANTS.

### 18. BALLED AND BURLAPPED MATERIAL SHALL COMPLY WITH THE FOLLOWING GUIDELINES:

- 18.1. TREES DESIGNATED B&B SHALL BE PROPERLY DUG WITH FIRM, NATURAL BALLS OF SOIL RETAINING AS MANY FIBROUS ROOTS AS POSSIBLE, IN SIZES AND SHAPES AS
- SPECIFIED IN THE AMERICAN STANDARD FOR NURSERY STOCK ANSI Z60.1.
- 18.2. ROOT BALLS SHALL BE FIRMLY WRAPPED WITH NONSYNTHETIC, ROTTABLE BURLAP AND SECURED WITH NAILS AND HEAVY, NONSYNTHETIC TWINE 18.3. ROOT COLLAR SHALL BE APPARENT AT SURFACE OF BALL, OR THE CONTRACTOR WILL BE RESPONSIBLE FOR REMOVING EXCESS SOIL FROM THE TOP OF THE
- 18.4. REMOVE ALL BURLAP, LACING, AND WIRE BASKET FROM AT LEAST THE TOP 1/2 OF THE ROOTBALL AND DISCARD FROM PLANTING HOLE. 18.5. DO NOT MANEUVER BY TRUNK. HANDLE BY ROOT BALL ONLY

# 19. CONTAINERIZED PLANTS SHALL COMPLY WITH THE FOLLOWING GUIDELINES:

- 19.1. MATERIAL SHALL HAVE FIRM, NATURAL BALLS OF SOIL RETAINING AS MANY FIBROUS ROOTS AS POSSIBLE, IN SIZES AND SHAPES AS SPECIFIED IN THE AMERICAN
- STANDARD FOR NURSERY STOCK ANSI Z60.1
- 19.2. ROOT COLLAR SHALL BE APPARENT AT SURFACE OF BALL, OR THE CONTRACTOR WILL BE RESPONSIBLE FOR REMOVING EXCESS SOIL FROM THE TOP OF THE
- 19.3. REMOVE CONTAINER PRIOR TO PLANTING.
- 20. TREES TO BE STAKED WILL BE DESIGNATED BY THE LANDSCAPE ARCHITECT. TREE STAKING FOR CANOPY AND LARGE EVERGREEN TREES SHALL NOT EXCEED 90 DAYS
- 21.1. ALL PLANT BEDS ARE TO RECEIVE A MINIMUM OF 4" OF APPROVED TOPSOIL TILLED IN TO A DEPTH OF 8" TO ENSURE INTEGRATION WITH EXISTING SOIL
- 21.2. APPROVED TOPSOIL IS TO BE PREFERABLY FROM ON-SITE STOCKPILE FROM STRIPPING OPERATIONS SEE EROSION AND SEDIMENT CONTROL PLANS. 21.3. IF ON-SITE TOPSOIL IS NOT AVAILABLE, CONTRACTOR SHALL PROVIDE TO SITE ACCORDINGLY.
- 22. ALL MULCH TO BE CERTIFIED TO BE FREE OF WEEDS, NON-NATIVE INVASIVE SPECIES AND THEIR LARVAE. MULCH SAMPLE SUBMITTAL SHALL BE PROVIDED TO LANDSCAPE ARCHITECT BEFORE SITE DELIVERY.

# SEEDING/SODDING NOTES

- 1. ROUGH GRADING TO BE COMPLETED PRIOR TO THE START OF PLANT INSTALLATION. SUBSTANTIAL COMPLETION SIGN-OFF BY LANDSCAPE ARCHITECT CONTRACTOR TO ENSURE NO CHANNELIZED FLOWS AROUND THE SITE.
- 2. ALL SEEDED/SODDED AREAS SHALL BE FINISHED GRADE AT THE THICKNESS OF THE SOD.
- 3. NO SEEDED/SODDED AREAS SHALL BE SODDED UNTIL ALL OTHER CONSTRUCTION ACTIVITIES, INCLUDING PLANTING AND MULCHING HAVE OCCURRED AND LANDSCAPE ARCHITECT HAVE REVIEWED THE FINAL GRADING.
- 4. SOD AREAS WILL BE ACCEPTED WHEN IN COMPLIANCE WITH ALL THE FOLLOWING CONDITIONS:
- 4.1. ROOTS ARE THOROUGHLY KNIT TO THE SOIL
- 4.2. ABSENCE OF VISIBLE JOINTS
- 4.3. ALL AREAS SHOW A UNIFORM STAND OF SPECIFIED GRASS IN HEALTHY CONDITION 4.4. AT LEAST 30 DAYS HAVE ELAPSED SINCE THE COMPLETION OF WORK UNDER THIS SECTION.
- 5. QUALITY GUARANTEE:
- 5.1. SOD SHALL BE UNIFORM IN COLOR, LEAF TEXTURE, LEAF AND ROOD DENSITY, AND FREE FROM WEED, DISEASES, AND OTHER VISIBLE IMPERFECTIONS AT TIME OF FINAL ACCEPTANCE. GUARANTEE DOES NOT COVER DAMAGE AS A RESULT OF FERTILIZERS, PESTICIDES, OR OTHER APPLICATIONS NOT SUPERVISED BY THE CONTRACTOR OR AS A RESULT OF ACTS OF GOD OR VANDALISM.
- 5.2. SEED SHALL BE UNIFORM IN COLOR, LEAF TEXTURE, LEAF AND ROOT DENSITY, AND FREE FROM WEED, DISEASES, AND OTHER VISIBLE IMPERFECTIONS AT TIME OF FINAL ACCEPTANCE. GUARANTEE DOES NOT COVER DAMAGE AS A RESULT OF FERTILIZERS, PESTICIDES, OR OTHER APPLICATIONS NOT SUPERVISED BY THE CONTRACTOR OR AS A RESULT OF ACTS OF GOD OR VANDALISM.
- 6. CONTRACTOR SHALL BE RESPONSIBLE FOR ENSURING THAT THE SEED/SOD IS PROPERLY IRRIGATED DURING THE GROW-IN PERIOD AND SHALL BE RESPONSIBLE IF THE SOD SUFFERS IRREPARABLE HARM.
- 7. SEED/SOD IS SUBJECT TO INSPECTION AND ACCEPTANCE. LANDSCAPE ARCHITECT AND/OR CLIENT RESERVES THE RIGHT TO REJECT AT ANY TIME OR PLACE PRIOR TO ACCEPTANCE, ANY WORK AND SOD WHICH IN THE LANDSCAPE ARCHITECTS OPINION FAILS TO MEET THESE SPECIFICATIONS REQUIREMENTS.
- 8. SOD STANDARDS:
- 8.1. GENERAL: HEALTHY, THICK TURF HAVING UNDERGONE A PROGRAM OF REGULAR FERTILIZATION, MOWING AND WEED CONTROL; FREE OF OBJECTABLE WEEDS; UNIFORM IN GREEN COLOR, LEAF TEXTURE AND DENSITY; HEALTHY, VIGOROUS ROOT SYSTEM; INSPECTED AND FOUND FREE OF DISEASE, NEMATODES, PEST AND PEST LARVAE BY THE ENTOMOLOGIST OF THE STATE DEPARTMENT OF AGRICULTURE
- 8.2. EACH PIECE OF SOD: SANDY-LOAM SOIL BASE THAT WILL NOT BREAK, CRUMBLE OR TEAR DURING SOD INSTALLATION.
- 8.3. THICKNESS: MINIMUM 3/4" THICK, EXCLUDING THE TOP GROWTH THATCH.
- 8.4. THATCH: NOT TO EXCEED 1/2" UNCOMPRESSED.
- 8.5. SIZE: CUT IN STRIPS 18" WIDE NO MORE THAN 24 HOURS PRIOR TO DELIVERY.
- 9. SOD DELIVERY, STORAGE AND HANDLING GUIDELINES ARE AS FOLLOWS:
- 9.1. SOD SHALL BE DELIVERED ON PALLETS PROPERLY LOADED ON VEHICLES AND WITH ROOT SYSTEM PROTECTED FROM EXPOSURE TO SUN, WIND, AND HEAT IN ACCORDANCE WITH STANDARD PRACTICE AND LABELED WITH BOTANICAL AND COMMON NAME OF EACH GRASS SPECIES IN ACCORDANCE WITH FEDERAL SEED ACT. SOD THAT HAS BEEN DAMAGED BY POOR HANDLING OR IMPROPER STORAGE IS SUBJECT TO REJECTION BY THE LANDSCAPE ARCHITECT OR OWNER.
- 9.2. PROTECT FROM DEHYDRATION, CONTAMINATION, FREEZING AND HEATING AT ALL TIMES. KEEP STORED SOD MOIST AND UNDER SHADE OR COVERED WITH
- MOISTENED BURLAP.
- 9.3. DO NOT DROP SOD ROLLS FROM CARTS, TRUCKS OR PALLETS. 9.4. DO NOT DELIVER MORE SOD THAN CAN BE INSTALLED WITHIN 36 HOURS
- 9.5. DO NOT STACK SOD MORE THAN 2 FEET DEEP.

# 10. SEED/SODDED BED PREPARATION:

- 10.1. ALL DEBRIS, ROCKS, ETC. LARGER THAN .5" ARE TO BE REMOVED PRIOR TO SEEDING/SODDING OR PLANTING.
- 10.2. ALL AREAS TO BE SEEDED/SODDED ARE TO RECEIVE A MINIMUM OF 2" OF APPROVED TOPSOIL TILLED INTO A DEPTH OF 4" TO ENSURE INTEGRATION WITH EXISTING
- 10.3. APPROVED TOPSOIL IS TO BE PREFERABLY FROM ON-SITE STOCKPILE FROM STRIPPING OPERATIONS SEE EROSION AND SEDIMENT CONTROL PLANS. 10.4. IF ON-SITE TOPSOIL IS NOT AVAILABLE, CONTRACTOR SHALL PROVIDE TO SITE ACCORDINGLY




Raleigh, NC 27604 | 919.805.3586

project status

Construction **Documents for BID** 

SCO ID# 19-21547-02A NCSU # 201920037

C-505

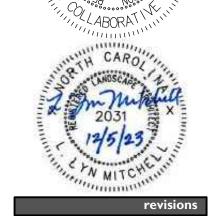

**I 12.05.23 BID ADDENDUM** 

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PROJECT **1368-20** DATE 10/16/2023 DRAWN **DB** CHECKED LM

sheet name PLANTING PLAN